
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third party without prior written consent.
Do not scale. Ofiginal d

SCALE SUMMARY

1000 @ /	A1 = 2000 @	A3 10	0 @ A1	= 200 @ A3
500 @ / 250 @ /	A1 = 1000 @	A3 50	@ A1	= 100 @ A3
250 @ /	A1 = 500 @	A3 25	@ A1	= 50 @ A3
200 @ /	A1 = 100 @	A3 10	@ A1	= 20 @ A3
150 @ /	A1 = 300 @	A3 5	@ A1	= 10 @ A3

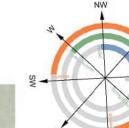

LEGAL DESCRIPTION Lot / DP / CB 10,3,4 / 12797, 21833 ZONING INFO: Earthquake Zone . Wind Zone: Planning Zone: Flood Management Zone

GENERAL NOTES:

All dimensions are nominal and are to be checked on site

Location of water supply, power & phone to be confirmed.

MASTERPLANNING LEGEND	
1 Bedroom House:	
2 Bedroom House:	
3 Bedroom House:	
4 Bedroom House:	
5 Bedroom House:	
Driveway:	
Footpath:	
Lawn Area:	in the state of the first
Landscaping:	
Waste & Recycle Areas:	
Refuse Bins:	
Timber Decking:	
Clotheslines (Fold out): 1,2m above FFL	
Letter Boxes:	4
New Water Meters:	□wм
Visibility splay: 2m x 1.5m	4 1
BULK & LOCATION	
Address: 43-47 Allens Road	, Ashburton 7700

2170 m²

Building Coverage:		
House 1:	90.4m ²	m²
House 2:	67.3m ²	m ²
House 3:	78.4m ²	m ²
House 4:	48.4m ²	m²
House 5:	48.4m²	m ²
House 6:	48.4m ²	m²
House 7:	48.4m²	m ²
House 8:	48.4m²	m²
House 9:	48.4m ²	m²
Total:	526.2m ²	759.5m ² max (35%)
Parking:	11 bays	11 bays
Bicycle Parks:	9 (In Shed)	1 (1 per House)
Building Setback:	>1.8m	1.8m
Road Setback:	3m	3m
Building Height:	<8m	8m

	Kainga Ora	Typology Le	gend
Unit Number	Typology	GFA	Net FA
1	H.05.01.01.UD	135m²	127.2m²
2	E.05.01.01	112.97m ²	106.99m ²
3	O.05.01.01	131.16m²	124.86m ²
4&5	B.05.01.01	158.5m ² (79.3m ² each)	150.60m ² (75.3m ² each)
6&7	B.05.01.01	158.5m ² (79.3m ² each)	150.60m ² (75.3m ² each)
8&9	B.05.01.01	158.5m ² (79.3m ² each)	150.60m ² (75.3m ² each)

HANDRAILS AND RAMPS NOTES

All external steps for FUD to have a maximum riser of 180mm and a minimum tread of 310mm with a clear width of 1200mm, and have the ability to install handrails in the future if required. All steps will require handrails where the change in level is more than 500mm high.

Accessible ramps are to be set at a maximum slope of 1:12 with a clear width of 1200mm.
Where the surface of an accessible route is more than 25mm above the adjacent ground, protection is to be provided by a 75 mm high ramp edge.

Handrails to be 1.1m high Juralco Viking balu as per specification.

LINE TYPES LEGEND	
	Site Boundary
	Existing Boundary
	Setback

RL 108.940-m RL 108.930 m RL 108.930 m RL 108.940 m House 7 2 0-16.02 4 (-16.0**)** Outdoor Living 94m RL 108.850 m RL 108.810 m RL 108.810 SL 108,960 UD Parking **ALLENS ROAD**

Consent Documents LUC23/0035 Sheet 1 of 11

Ashburton District Council

Approved District Planning

1 Ground Floor 0-16.01 Scale 1 : 150 @ A1

Kāinga Ora
Homes and Communities

NORTH

HDS - 43-47 Allens Road - AR 112275 43-47 Allens Road, Allenton,

Ashburton 7700

Revision Schedule H1259-047 Resource Consent RC-RFI RC-RFI 2-ODL Area


RESOURCE CONSENT Date sue Date: 14/06/23 03/05/23 Drawn By: KTC Checked By: MP Sheet No: 0-11.03 Scale: As indicated @ A1

Bulk and Location Plan - Ground



SCALE SUMMARY


1000	@ A1	= 2000	@ A3	100	@ A1	= 200	@ A3
500	@ A1	= 1000	@ A3	50	@ A1	= 100	@ A3
250	@ A1	= 500	@ A3	25	@ A1	= 50	@ A3
200	@ A1	= 100	@ A3	10	@ A1	= 20	@ A3
150	@ A1	= 300	@ A3	5	@ A1 @ A1 @ A1 @ A1 @ A1	= 10	@ A3

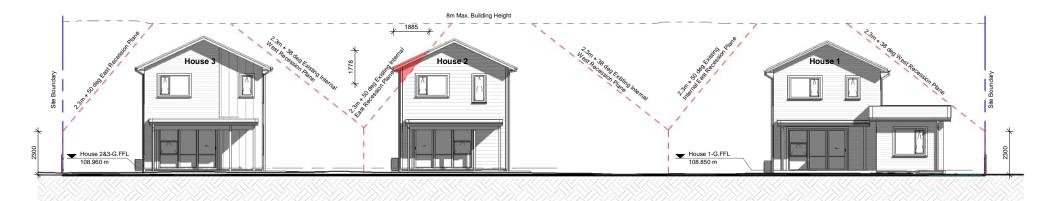

Internal Elevation 1 0-11.03 Scale 1:100 @ A1 8m Max. Building Height House 4 House 1 House 4&5-G.FFL 108.950 m House 1-G.FFL 108.850 m

Internal Elevation 2
0-11.03 Scale 1:100 @ A1



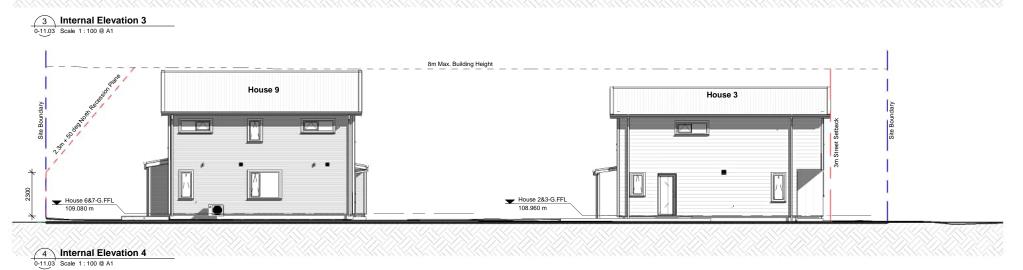

Approved District Planning Consent Documents LUC23/0035 Sheet 2 of 11 **Ashburton District Council**

Hierarchy Group.



HDS - 43-47 Allens Road - AR 112275 43-47 Allens Road,

Allenton,

Ashburton 7700

Revision Schedule H1259-047 Description Resource Consent RC-RFI

RESOURCE CONSENT **General Arangement Elevations** Date Issue Date: 06/06/23 03/05/23 Drawn By: KTC Checked By: MP Scale: As indicated @ A1

ELEV	Wall Cladding 1	Fibre Cement Weatherboard
	Colour	Refer to material specifications
	Wall Cladding 2 Colour	Board and Batten Cladding Refer to material specifications
	Roof Cladding Colour	Colorsteel Corrugated Roofing Refer to material specifications

MAXIMUM HEIGHT	
Maximum Height	8.0 Meters*

NOTE

Clothes lines, Garden Sheds, Rubbish Bins and Vehicles are excluded from views

All decking shall have adequate slip-resistant walking surfaces under all conditions of normal use in accordance to D1/AS1 section 2.1.1 Slip Resistance.

Deck exempt from Building Consent proprietary balustrade system as per specification

Recession Planes	
Elevation	Description
	In
North Elevation	2.3m + 50 ° North Recession Plane
South Elevation	4.5m - Street Setback Line
East Elevation	2.3m + 50 ° East Recession Plane
West Elevation	2.3m + 38 ° West Recession Plane
Existing Internal Elevation	2.3m + 50 ° East Existing Internal Recession Plane
Existing Internal	2.3m + 38°West Existing Internal -

ELEVATION LEGEND HOUSE 1		
Wall Cladding 1	Weatherboard Cladding	
Colour:	Dulux Whisper White	
Wall Cladding 2	Board and Batten Cladding	
Colour:	Dulux Colorsteel Slate	
Roof Cladding	Colorsteel Corrugated Roofing	
Colour:	Dulux Mt Inaccessible	
Timber	Pergolas/Fences	
Colour:	Intergrain Mid Oak Stain	
Aluminium Joinery Colour:	Off White Matt	

ELEVATION LEGEND HOUSE 2		
Wall Cladding 1	Weatherboard Cladding	
Colour:	Dulux Whisper White	
Wall Cladding 2	Board and Batten Cladding	
Colour:	Dulux Lichen	
Roof Cladding	Colorsteel Corrugated Roofing	
Colour:	Dulux Mt Inaccessible	
Timber	Pergolas/Fences	
Colour:	Intergrain Mid Oak Stain	
Aluminium Joinery Colour:	Off White Matt	

Wall Cladding 1	Weatherboard Cladding
Colour:	Dulux Lichen
Wall Cladding 2	Board and Batten Cladding
Colour:	Dulux Whisper White
Roof Cladding	Colorsteel Corrugated Roofing
Colour:	Dulux Mt Inaccessible
Timber	Pergolas/Fences
Colour:	Intergrain Mid Oak Stain
Aluminium	
Joinery Colour:	Off White Matt

Wall Cladding 1 Colour:	Weatherboard Cladding Dulux Slate Mt Aspiring 1/4	
Wall Cladding 2 Colour:	Board and Batten Cladding Dulux Ohai	
Roof Cladding Colour:	Colorsteel Corrugated Roofing Dulux Mt Inaccessible	
Timber Colour:	Pergolas/Fences Intergrain Mid Oak Stain	
Aluminium Joinery Colour:	Off White Matt	





1.0 - 1.8m High timber paling driveway visibility fence. 1m length panel to extend atleast 2m in length. Confirm on site. *



1.8m High timber paling fence *




1.8m High timber board and batten fence. Battens to face the street/JOAL/Northern Property*

1.8m High timber board and batten fence (Battens on both sides).



1.8m High timber board and batten fence (0.3m permeable top). Battens to face the street/JOAL*

Approved District Planning
Consent Documents
LUC23/0035
Sheet 4 of 11
Ashburton District Council

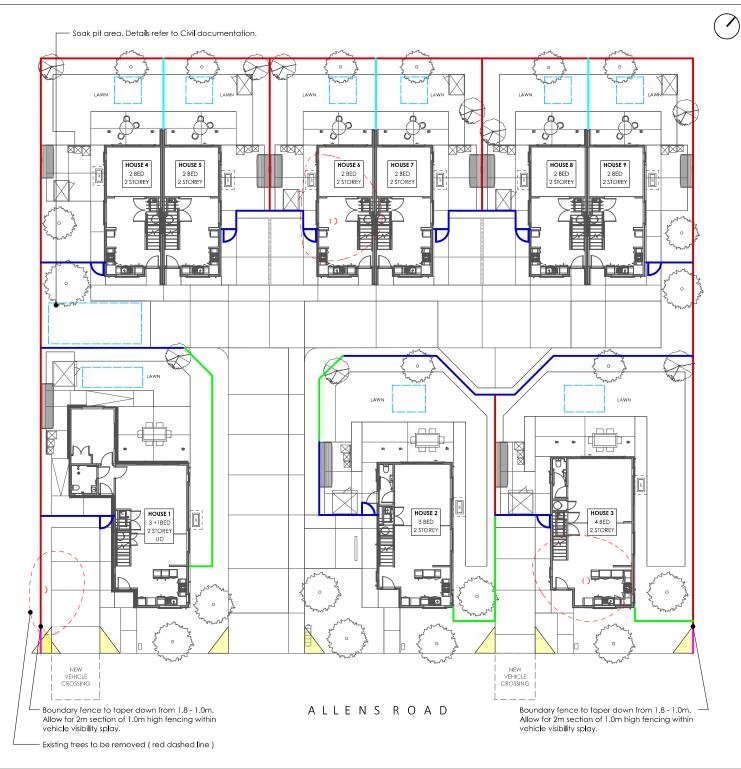

43 - 47 ALLENS RD

ADDRESS

43 - 47 Allens Road, Allenton Ashburton, 7700

CHENT




FENCING MASTERPLAN

SITE WIDE

RESOURCE CONSENT

NOTES

- Confirm set out of all dimensions on site prior to commencing work.
- 2. Do not scale off drawings.
- All gates to match adjacent fencing type, unless specified otherwise.
- All gates for standard housing units to be 0.95m wide.
- All gates for FUD and accessible units to have a low latch and self-closing hinges.
- 4. *Allow to stain all exposed visible surface of timber polling fencing facing the street/JOAL or as indicated on fencing plan, Apply 2 coats charcool limber stain, colour Resene 'Shadow Match' or similar approved by Landscape Architect.
- Prior to excavating fencing post holes, confirm on site there are no clashes with underground services. Notify the Landscape Architect if any clashes are likely to occur.
- A 3 months Defects Liability Period shall be included for all Hard Landscaping.

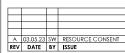




e Uruti Building, 48 Hereford St. PO Box 2833, Christchurc

r. 03 3668 181 E. admin@komomarsh.co.nz W. kamomarsh.co.nz

Design SW Drawn SW Check AP	Date 03.05.23 Scale 1:200@A3

REF. NO. 5252_V_45

PAGE RC-LD-1300 REVISION A

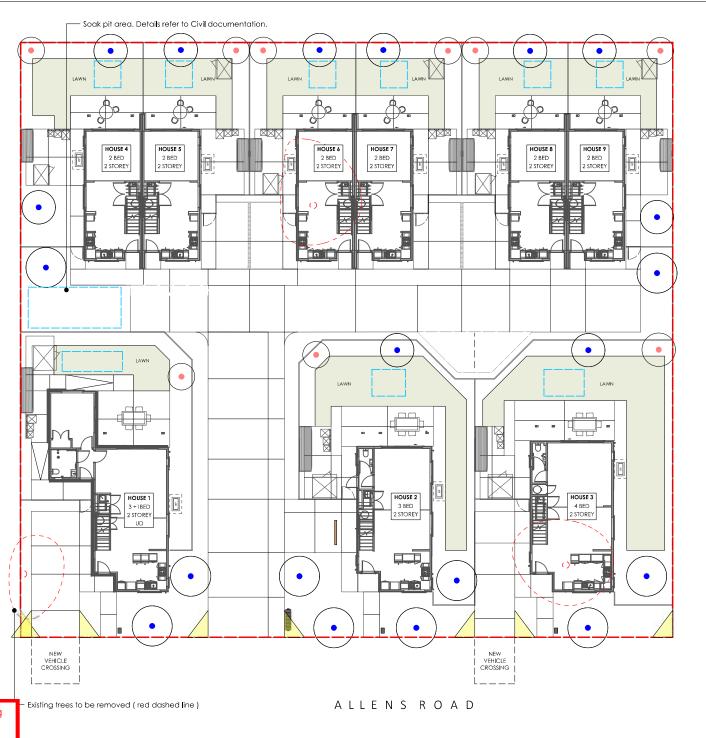

43 - 47 ALLENS RD

43 - 47 Allens Road, Allenton Ashburton, 7700



SPECIMEN TREE & PLANTING PALETTE

SITE WIDE

RESOURCE CONSENT

NOTES

- Confirm set out of all dimensions on site prior to commencing work. Do not scale off drawings.
- All plans to be read in conjuction with Hierarchy Group Architecture Plan Set and Beca Engineer Plan Set.
- All trees shall be at least 1.5m high at the time of planting and once established must be maintained at a height of at least 3m thereafter (with the exception of any proposed fruit trees).
- 4. All landscaping shall be established on site within the first planting season (extending from 1 April to 30 September) following the final, passed building inspection.
- 5. All landscaping shall be maintained and if dead, diseased, or damaged, shall be replaced by the consent holder within the following planting season (extending from 1 April to 30 September) with trees/shrubs of similar species to the existing landscaping and capable of achieving a minimum height of 3m (with the exception of any fruit trees). 6. Specimen tree locations are indicative.

LEGEND

Proposed specimen tree

Proposed fruit tree

(Existing tree to be removed

Soak pit area (by Civil)

Visibility splay - all fencing and planting to be max. 1.0m high in visibility splay

Acer palmatum Hoheria angustifolia Magnolia grandiflora 'Little Gem' Plagianthus regius Pseudopanax crassifolius Sophora microphylla

INDICATIVE SPECIMEN TREE SPECIES

INDICATIVE FRUIT TREE SPECIES


Feijoa spp. Citrus spp. Malus spp. Prunus spp Pyrus spp.

INDICATIVE SHRUB & GROUNDCOVER SPECIES

Libertia spp. Muehlenbeckia spp. Phormium spp. Astelia spp. Carex spp. Dianella spp. Corokia spp. Chinochloa flavicans Mondo grass Alternanthera 'Little Ruby' Arthropodium spp. Pratia angulata Lomandra spp. Hebe spp. Griselinia littoralis Pittosporum spp.

- Planting around car parks to be low, dense and robust for visibility and to prevent vehicle access.

Planting in visibility splay to be max.
 1.0m high for vehicle visibility.

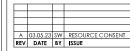



Te Uruti Bullding, 48 Hereford St. PO Box 2833, Christchurch 8140 Mountaineer Bullding, 32 Rees St. Queenstown 9300

T. 03 3668 181 E. admin@kamomarsh.co.nz W. kamomarsh.co.nz

W. kamomarsh.co.nz	
	Date 03.05.23 Scale 1:200@A3

Check AP REF. NO. PAGE RC-LD-1700 REVISION A 5252_V_45

Approved District Planning Consent Documents LUC23/0035 Sheet 5 of 11 Ashburton District Council

Approved District Planning Consent Documents LUC23/0035 Sheet 6 of 11 **Ashburton District Council**

HDS - 43-47 Allens Road - AR 112275

43-47 Allens Road, Allenton, Ashburton 7700





RESOURCE CONSENT

Hierarchy Group.


Issue Date: 03/05/23 Drawn By: KTC Scale: @ A1

Cover Sheet





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LEGAL DESCRIP	rion			
Address:	43-47 Allens Ashburton 77	Road, Al	lenton,	
	10,3,4 /	12797	7,	
ZONING INFO:		2163	,	
Wind Region:			A	
Earthquake Zone:			1	
Exposure:			В	
Wind Zone: Planning Zone:			Mediu	im
Flood Managemen	t Zone:		No	
GENERAL NOTES	:			
All dimensions are before commencin	nominal and	are to be	check	ed on site
Dimensions are sh	owing to clade	ding face).	
All work to comply	with the releva	ant section	on of th	e New
Zealand Building C				
Location of water s	upply, power	& phone	to be o	confirmed.
MASTERPLAN	NING LEG	END		
1 Bedroom House:				
2 Bedroom House:				
3 Bedroom House:				
4 Bedroom House:				
5 Bedroom House:				
Driveway:				
Footpath:				The same
Lawn Area:				
Landscaping:				
Waste & Recycle A	reas:			
Refuse Bins:				
Timber Decking:				
Clotheslines (Fold	out): 1,2m abo	ve FFL		
Letter Boxes:			4	EHE
New Water Meters:				WM
Visibility splay: 2m :	< 1.5m		- 1	15.
BULK & LOCATIO				
Address:	43-47 Aller	ns Road,	Ashbu	irton 7700
Total Site Area:	2170 m²			
	Provided	F	Require	ed/Maximu
Building Coverage				
House 1:	90.4m²	-	m2	
House 2:	67.3m ²	- 1	m ²	
House 3:	78.4m²	- 1	m²	
House 4:	48,4m²	-	m2	
House 5:	48.4m²	-	m²	
House 6:	48.4m²		m²	
House 7:	48.4m²		m2	
House 8:	48.4m²	- 1	m²	
House 9:	48,4m²		m2	
Total:	526.2m ²		759.5m	²max (35%
Parking:	11 bays		11 bays	
-	9 (In Shed		1 (1 no	House)
Bicycle Parks:				

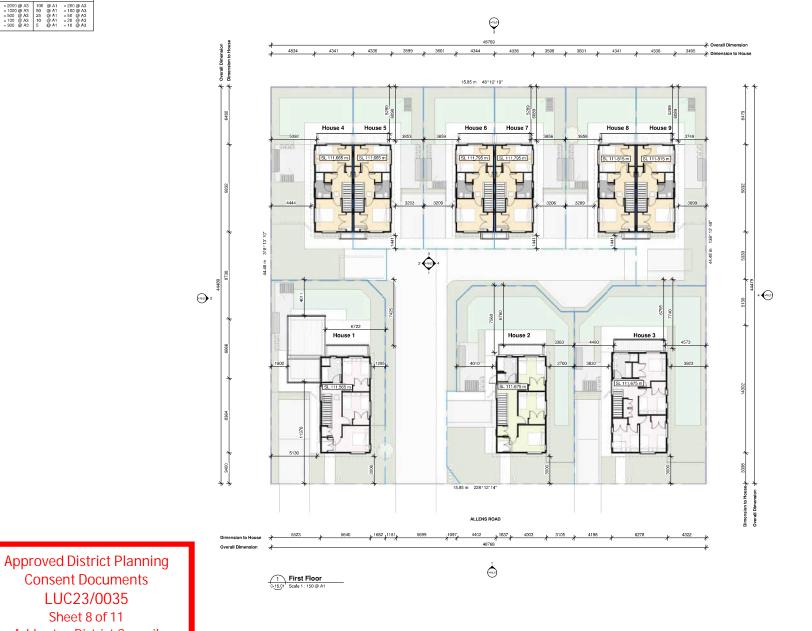Road Setback: 3m				1.80	.8m	
				3m		
		<8m	n 8m		1	
_						
	Kainga	Ora '	Typology	Le	gend	
Unit Number	Typolo	gv	GFA		Net FA	
1	H.05.01.01.FUD		135m²		127.2m²	
2	E.05.01.01		112.97m ²		106.99m²	
3	O.05.11.01		131.16m²		124.86m²	
485	B.05.01.01		158.5m ² (79.3m ² each)		150.60m ² (75.3m ² each)	
6&7	B.05.01.01		158,5m² (79,3m² eac	h)	150,60m² (75,3m² each)	
8&9	B.05.01.01		158.5m²		150.60m²	

Note: Refer to Kamo Marsh drawing set for hard and soft landersning setout and plant species.

Hierarchy Group.

Consent Documents

LUC23/0035 Sheet 8 of 11 **Ashburton District Council**



NORTH


HDS - 43-47 Allens Road - AR 112275
Address: 43-47 Allens Road, Allenton, Ashburton 7700

Revision Schedule H1259-047 Description Date

RESOURCE CONSENT Bulk and Location Plan - First Floor Issue Date: 03/05/23 rawn By: KTC Checked By: MP o: 0-11.04 cale: As indicated @ A1



Site 1 **Luminaire layout plan**

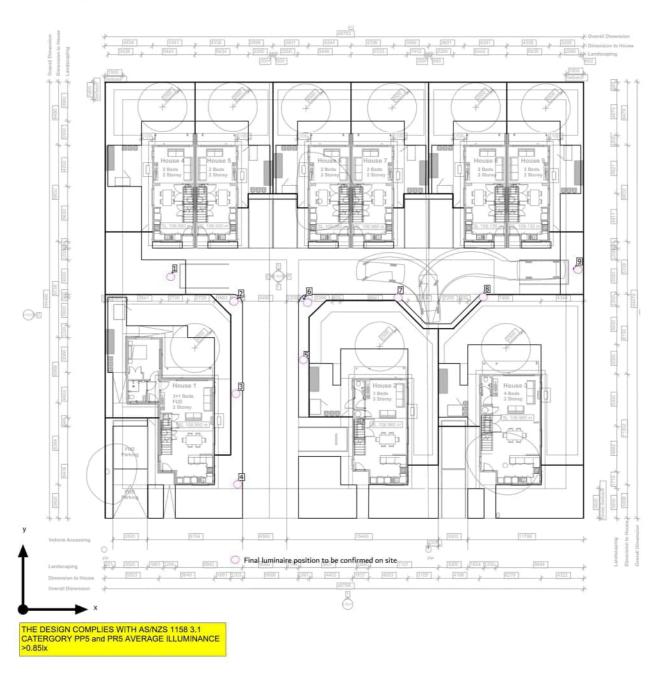

Approved District Planning
Consent Documents
LUC23/0035
Sheet 9 of 11
Ashburton District Council

据Beca Kāinga Ora
Homes and Communities

Original Scale (A1) 1:125 P1 Rev. A

for shared trenching with 3 waters services

43-47 ALLENS ROAD

ALLENTON

ASHBURTON

A ISSUED FOR RESOURCE CONSENT



108.9

108.9

108.9

- Refer to drawing CV-002 for general civil notes.
- 2. Cut/fill of the foundation is considered, but not shown on the plan.
- 3. Spot heights represent finished ground levels

Colour	Minimum Elevation (m)	Maximum Elevation (m)
	0.2	0.3
	0.1	0.2
	0.0	0.1
	-0.1	0.0
	-0.2	-0.1

Volumes : Cut \ Fill			
	Whole Site		
	Cut (m³)	Fill (m³	
Stage 1 -From existing to site scrape	684	0	
Stage 2 - From site scrape to subgrade	17	195	
Stage 3 - From subgrade to finished	0	748	
Total	701	943	

HOUSE 4 & 5 FFL = 108.95 Ex. Ground avg. = 108.67 HOUSE 6 & 7 FFL = 109.08 Ex. Ground avg. = 108.73 HOUSE 8 & 9 FFL = 109.10 Ex. Ground avg. = 108.78 Subgrade avg. = 108.50 Subgrade avg. = 108.35 Subgrade avg. = 108,48 108.6 108.7 108.8 108.9 108.9 108.8 108.9 108.8 108.6 108.7 108.8 108.9 108.9 108.8 108.6 108.7 108.8 108.8 108.8 108.9 108,9 108,9 108.8 108.9 108.7 108.7 108.7 108.7 108.7 108.8 108.8 108.6 108.7 108.6 108.6 108.7 108.7 108.7 108.6 108.6 108.6 108.6 108.7 108.7 108.7 108.7 108.7 108.8 108.9 108.8 108.8 108.7 108.7 108.7 108.8 108.6 108.6 108.7 108.7 108.8 108.8 108.8 108.7 108.7 108.7 108.7 108.8 108.6 108.8 108.8 108.6 108.6 108.7 108.6 108.6 108.7 108.7 108.8 108.8 108.7 108.7 108.7 Extent of reinforced gravel raft. Typical HOUSE 2 108.8 108.8 108.6 108.6 108.7 108.7 108.8 108.8 108.7 108.8 FFL = 108.96 Ex. Ground avg. = 108.68 Subgrade avg. = 108.36 FFL = 108.96 Ex. Ground avg. = 108.68 Subgrade avg. = 108.36 FFL = 108.85 Ex. Ground avg. = 108.56 Subgrade avg. = 108.25 House foundation Typical 108.7 108.7 108.8 108.7 108.8 108.6 108.6 108.7 108.7 108.7 108.7 108.6 108.6 108.7 108.7 108.7 108.7 8.801

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| Original | Design N. Yung | Rose (A1) | Design N. Yung | Rose (A2) | Design R. Sharma | Design R. Sharma | Rose (A2) | Des

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ALLENS ROAD

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EARTHWORKS PLAN OVERALL EXI

XISTING TO FINAL	
調Beca	Kāi

🍸 Kāinga Ora

43-47 ALLENS ROAD ALLENTON **ASHBURTON**

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EARTHWORKS PLAN

CIVIL 3160491 AR112275-CV-131

RESOURCE CONSENT NOT FOR CONSTRUCTION

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107-
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-11
4
~
23
128

A ISSUED FOR RESOURCE CONSENT

Approved District Planning

Consent Documents

LUC23/0035

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Ashburton District Council