



WAITOMO ASHBURTON WEST STREET (SH1), ASHBURTON

DRAWING LIST

DWG NO	DIDWG NAME	Rev.	DATE
000 CO\	/ER & LEGENDS		
000-01	SHEET LIST	L	13.12.2021
100 EXIS	STING SITE		
110-01	EXISTING SITE PLAN	-	19.10.2020
110-04	DEMOLITION SITE PLAN	A	19.10.2020
200 GA	PLANS		
210-01	LOCATION PLAN	J	13.12.2021
210-02	PROPOSED PLAN	L	13.12.2021
210-03	SETOUT PLAN	В	13.12.2021
210-04	PAVEMENT SURFACES	В	13.12.2021
210-05	TANKER PATH	1	13.12.2021
210-07	EARTHWORKS PLAN	-	15.09.2021
210-08	LANDSCAPE PLAN	D	13.12.2021
250-01	ELEVATION SHEET 01	В	21.11.2021
610-03	SIGHT LINES	-	29.11.2021
600 HSN	10		
610-01	SITE PLAN	В	13.12.2021
640-01	DETAIL SHEET 01		15.09.2021

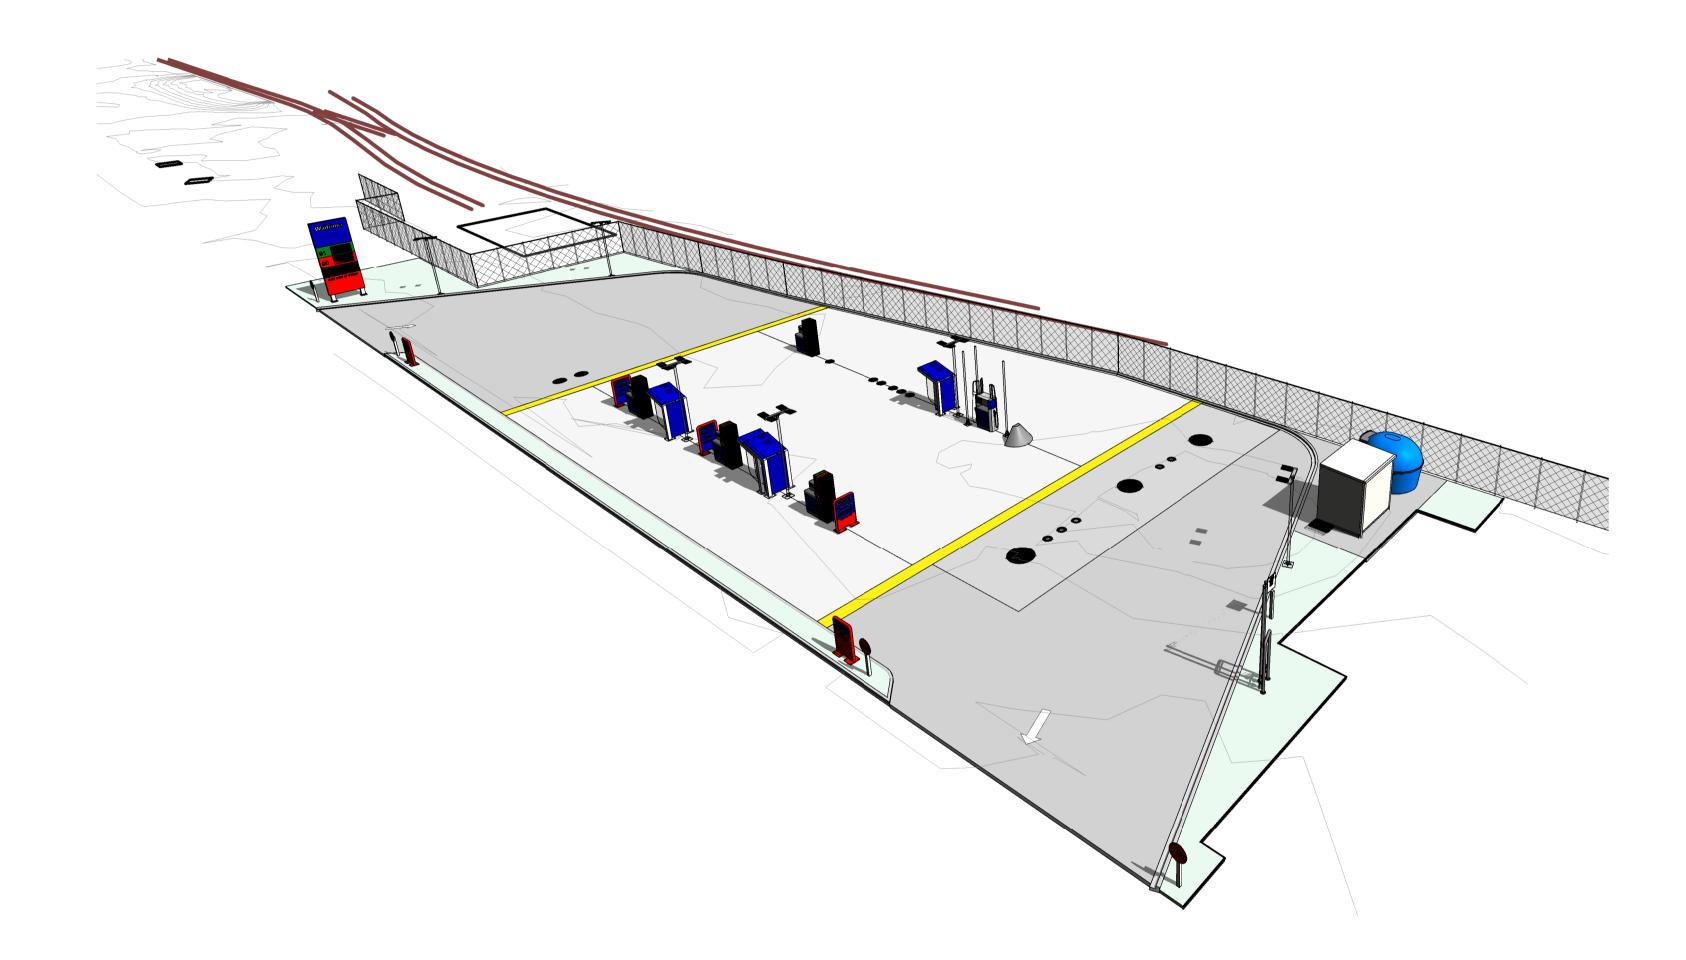



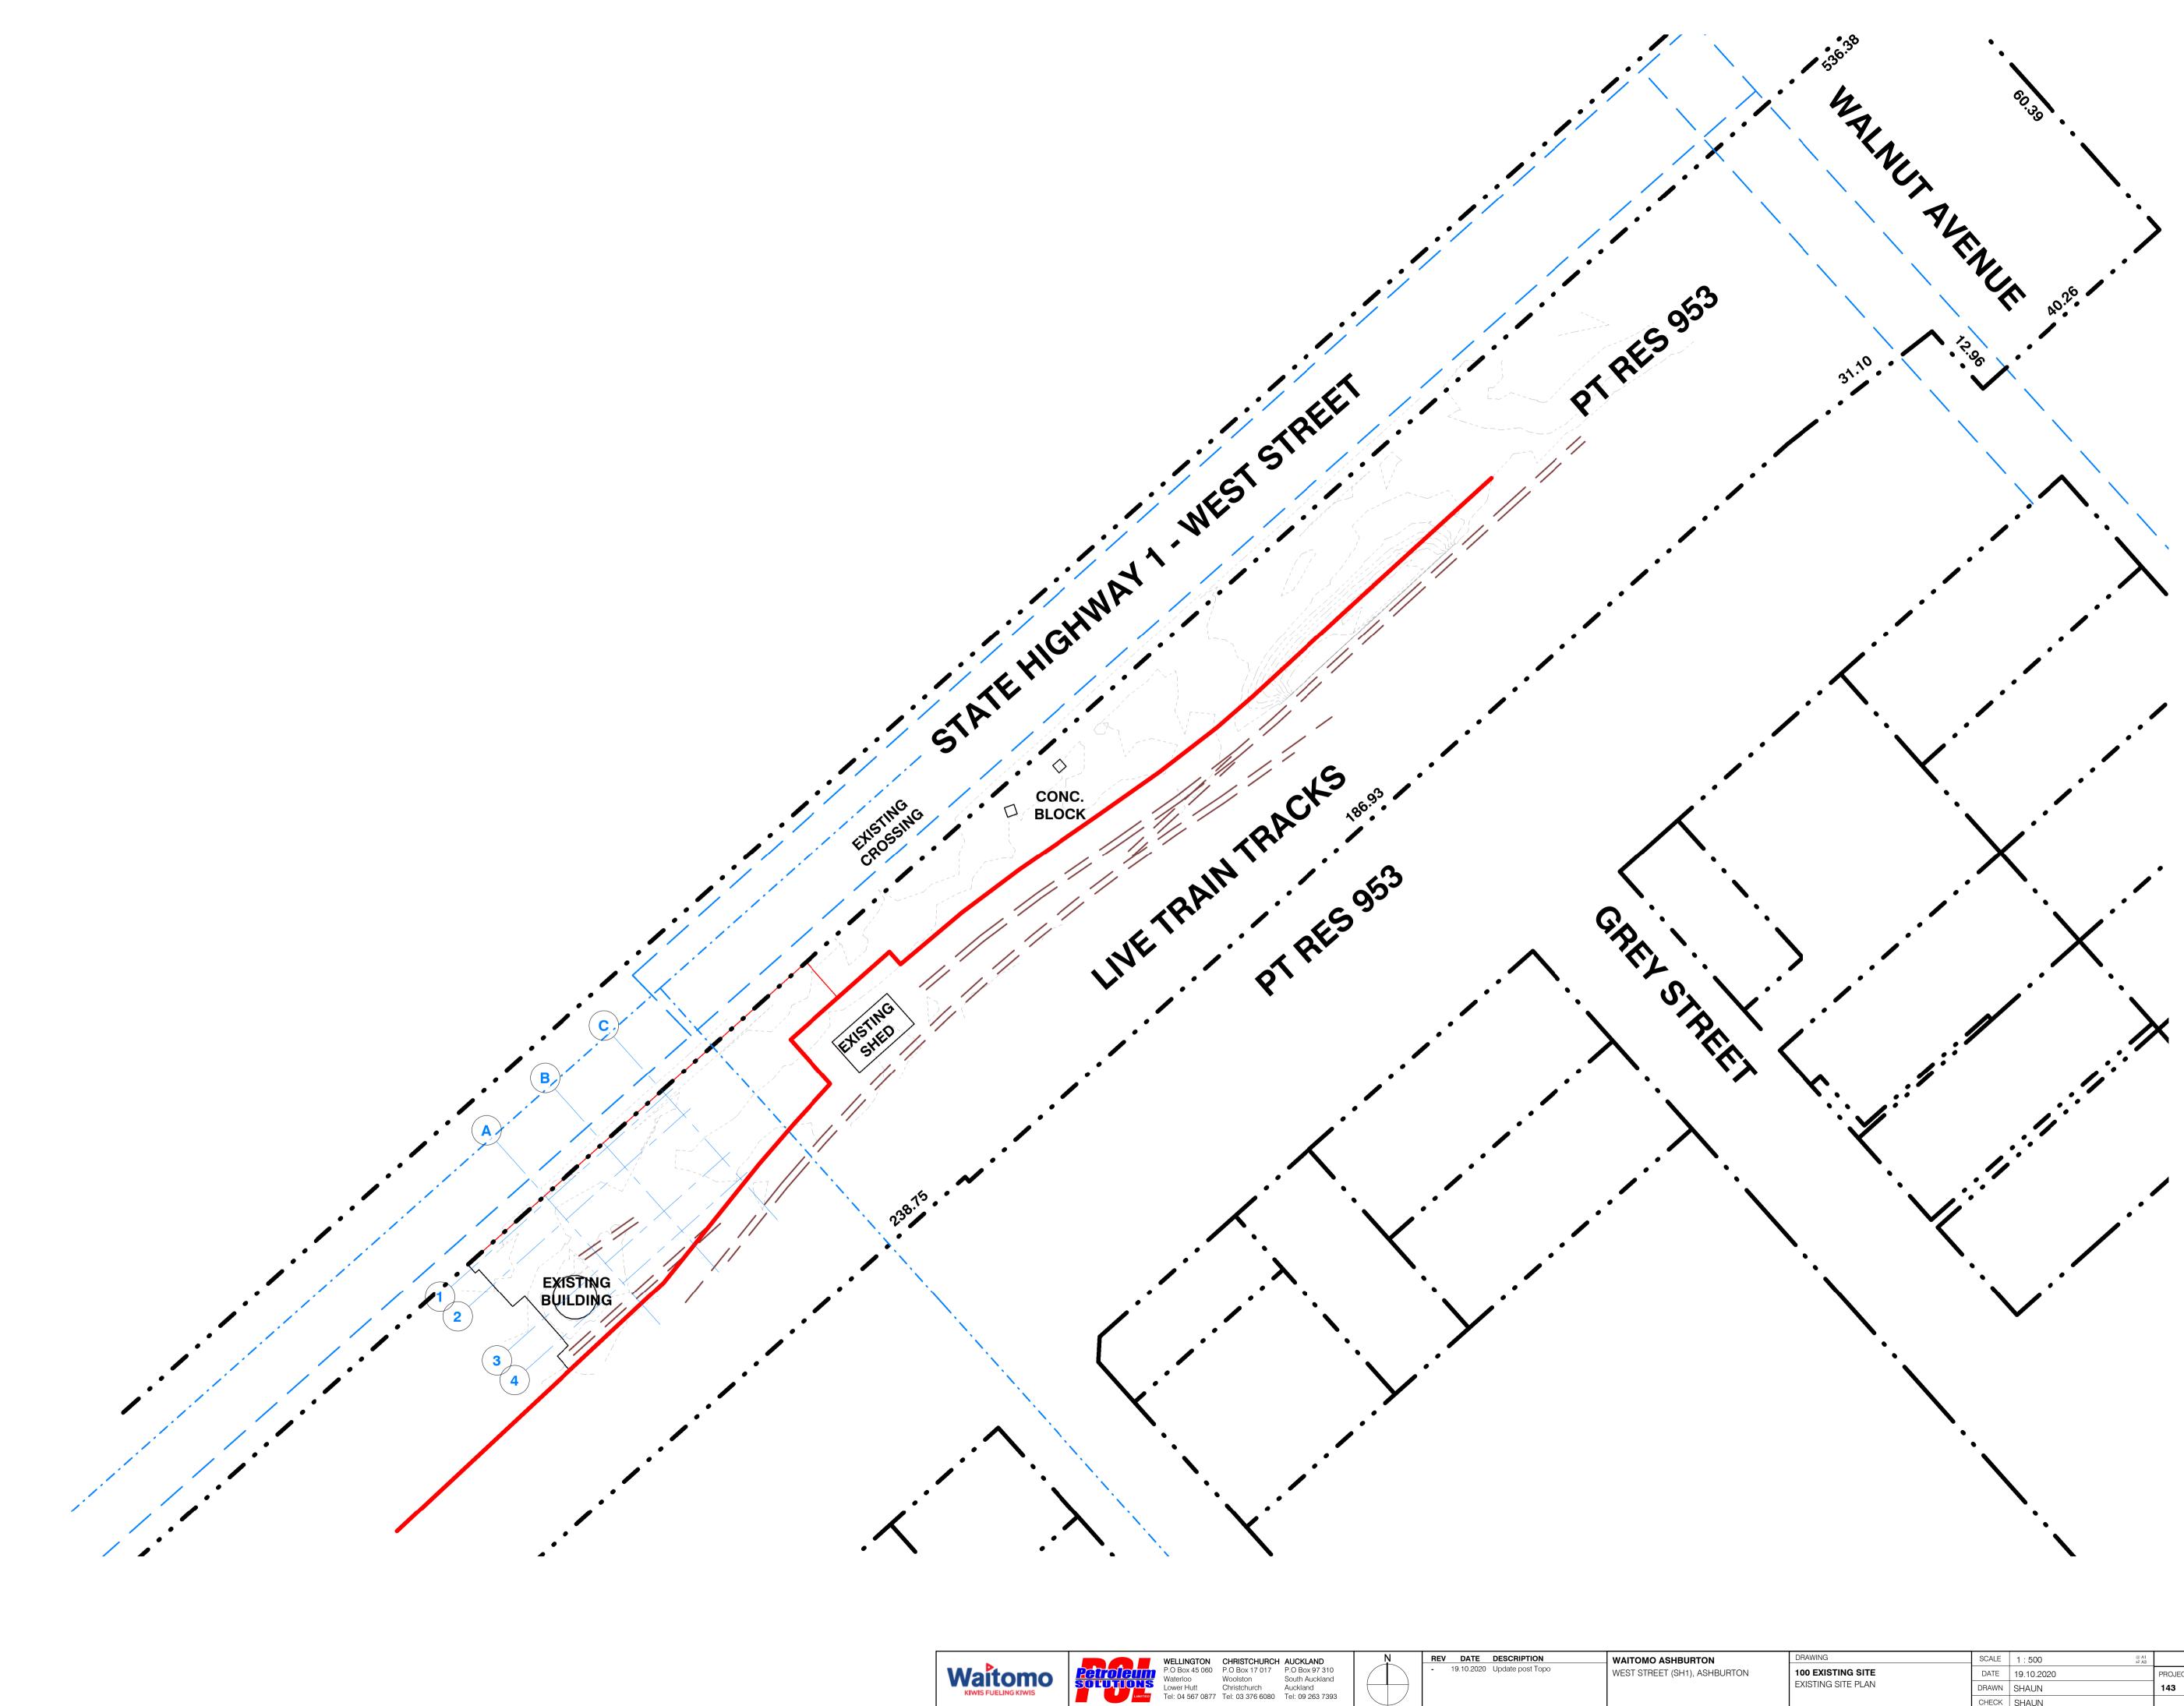

WAITOMO ASHBURTON	DRAWING	SCALE	1:500 ^{@ A1}	PLA	NNING	
WEST STREET (SH1), ASHBURTON	100 EXISTING SITE	DATE	19.10.2020	PROJECT NO.	DRW NO.	REV.
	EXISTING SITE PLAN	DRAWN	SHAUN	143	110-01	-
		CHECK	SHAUN			




PROPOSED SITE 1535m²




WAITOMO ASHBUR WEST STREET (SH1), J

JRTON	DRAWING	SCALE	1:500 ^{@ A1}	PLA	NNING	
1), ASHBURTON	100 EXISTING SITE DEMOLITION SITE PLAN	DATE	19.10.2020	PROJECT NO.	DRW NO.	REV.
		DRAWN	SA	143	110-04	Α
		CHECK	ТА			

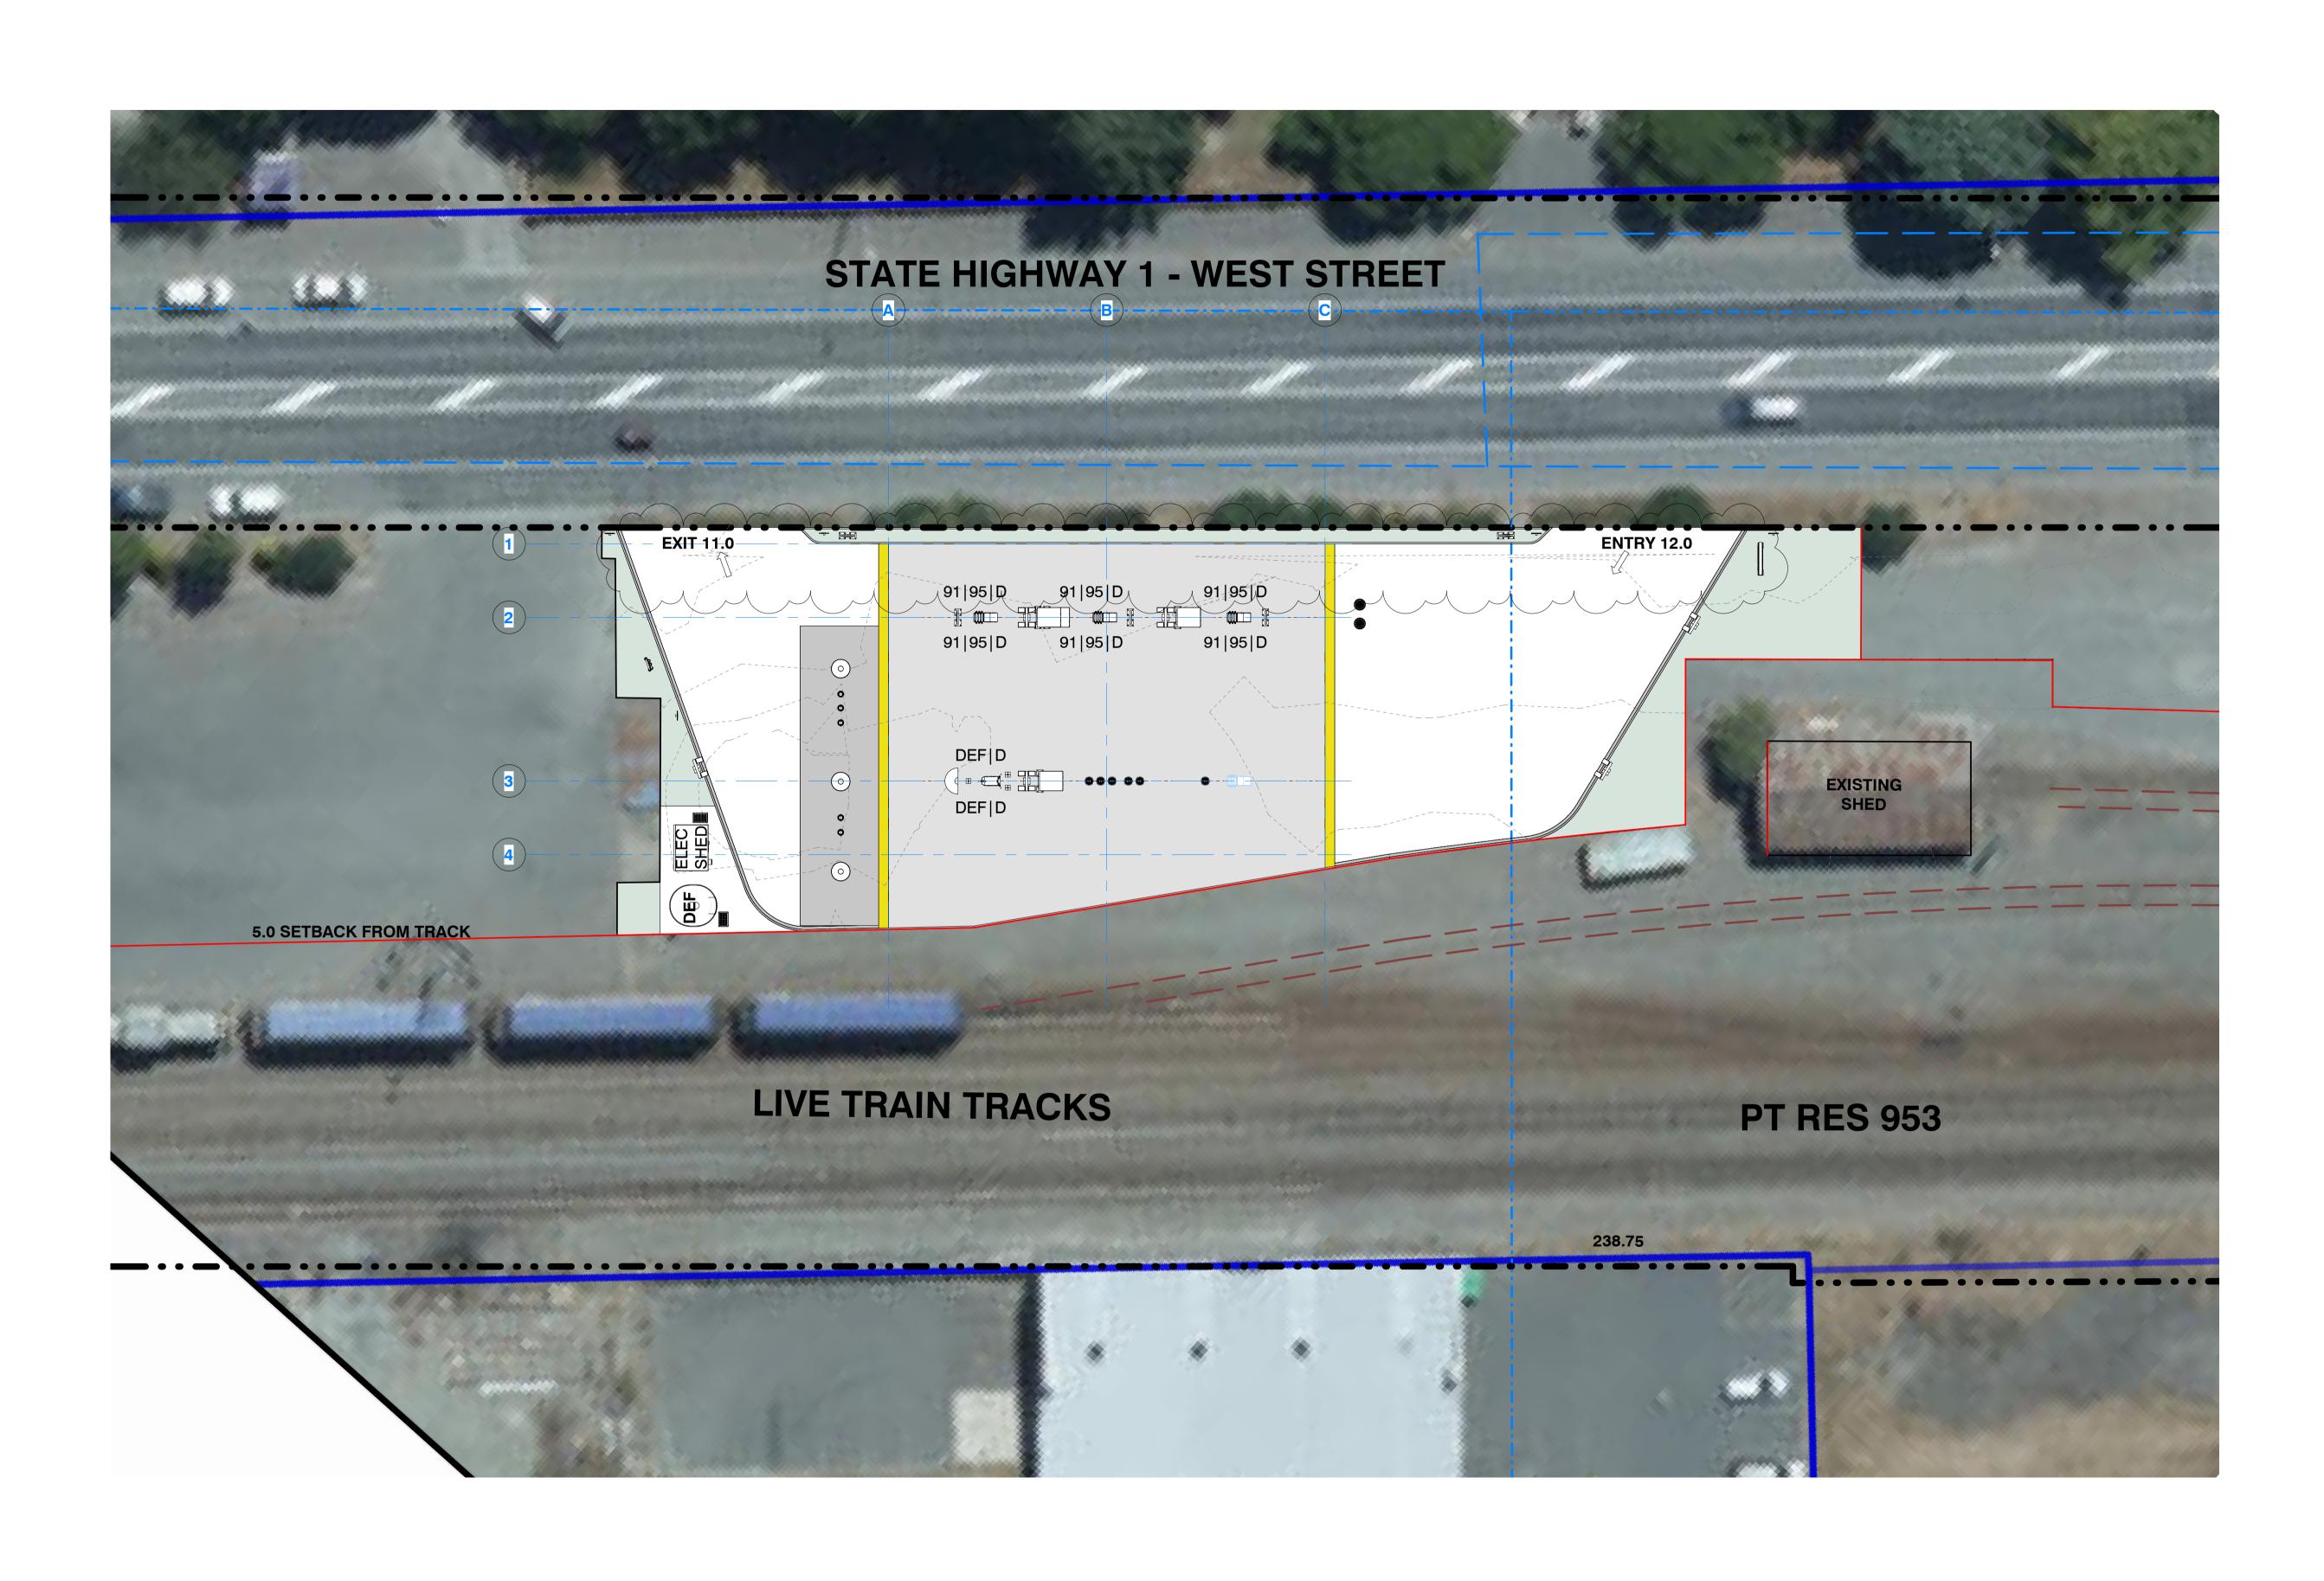



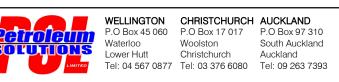



 REV
 DATE
 DESCRIPTION


 F
 25.06.2021
 Update to single 110kl tank.

 G
 30.07.2021
 Update dispenser configuration

 H
 02.11.2021
 ADD ENTRY SIGN
 I 10.12.2021 ADD DIRECTIONAL ARROWS

WEST STREET (SH1)

URTON	DRAWING	SCALE	1:200 ^{@ A1}	PLANNING	
11), ASHBURTON	200 GA PLANS	DATE	13.12.2021	PROJECT NO. DRW NO. REV	Ι.
	LOCATION PLAN	DRAWN	SHAUN	143 210-01 J	
		CHECK	SHAUN		

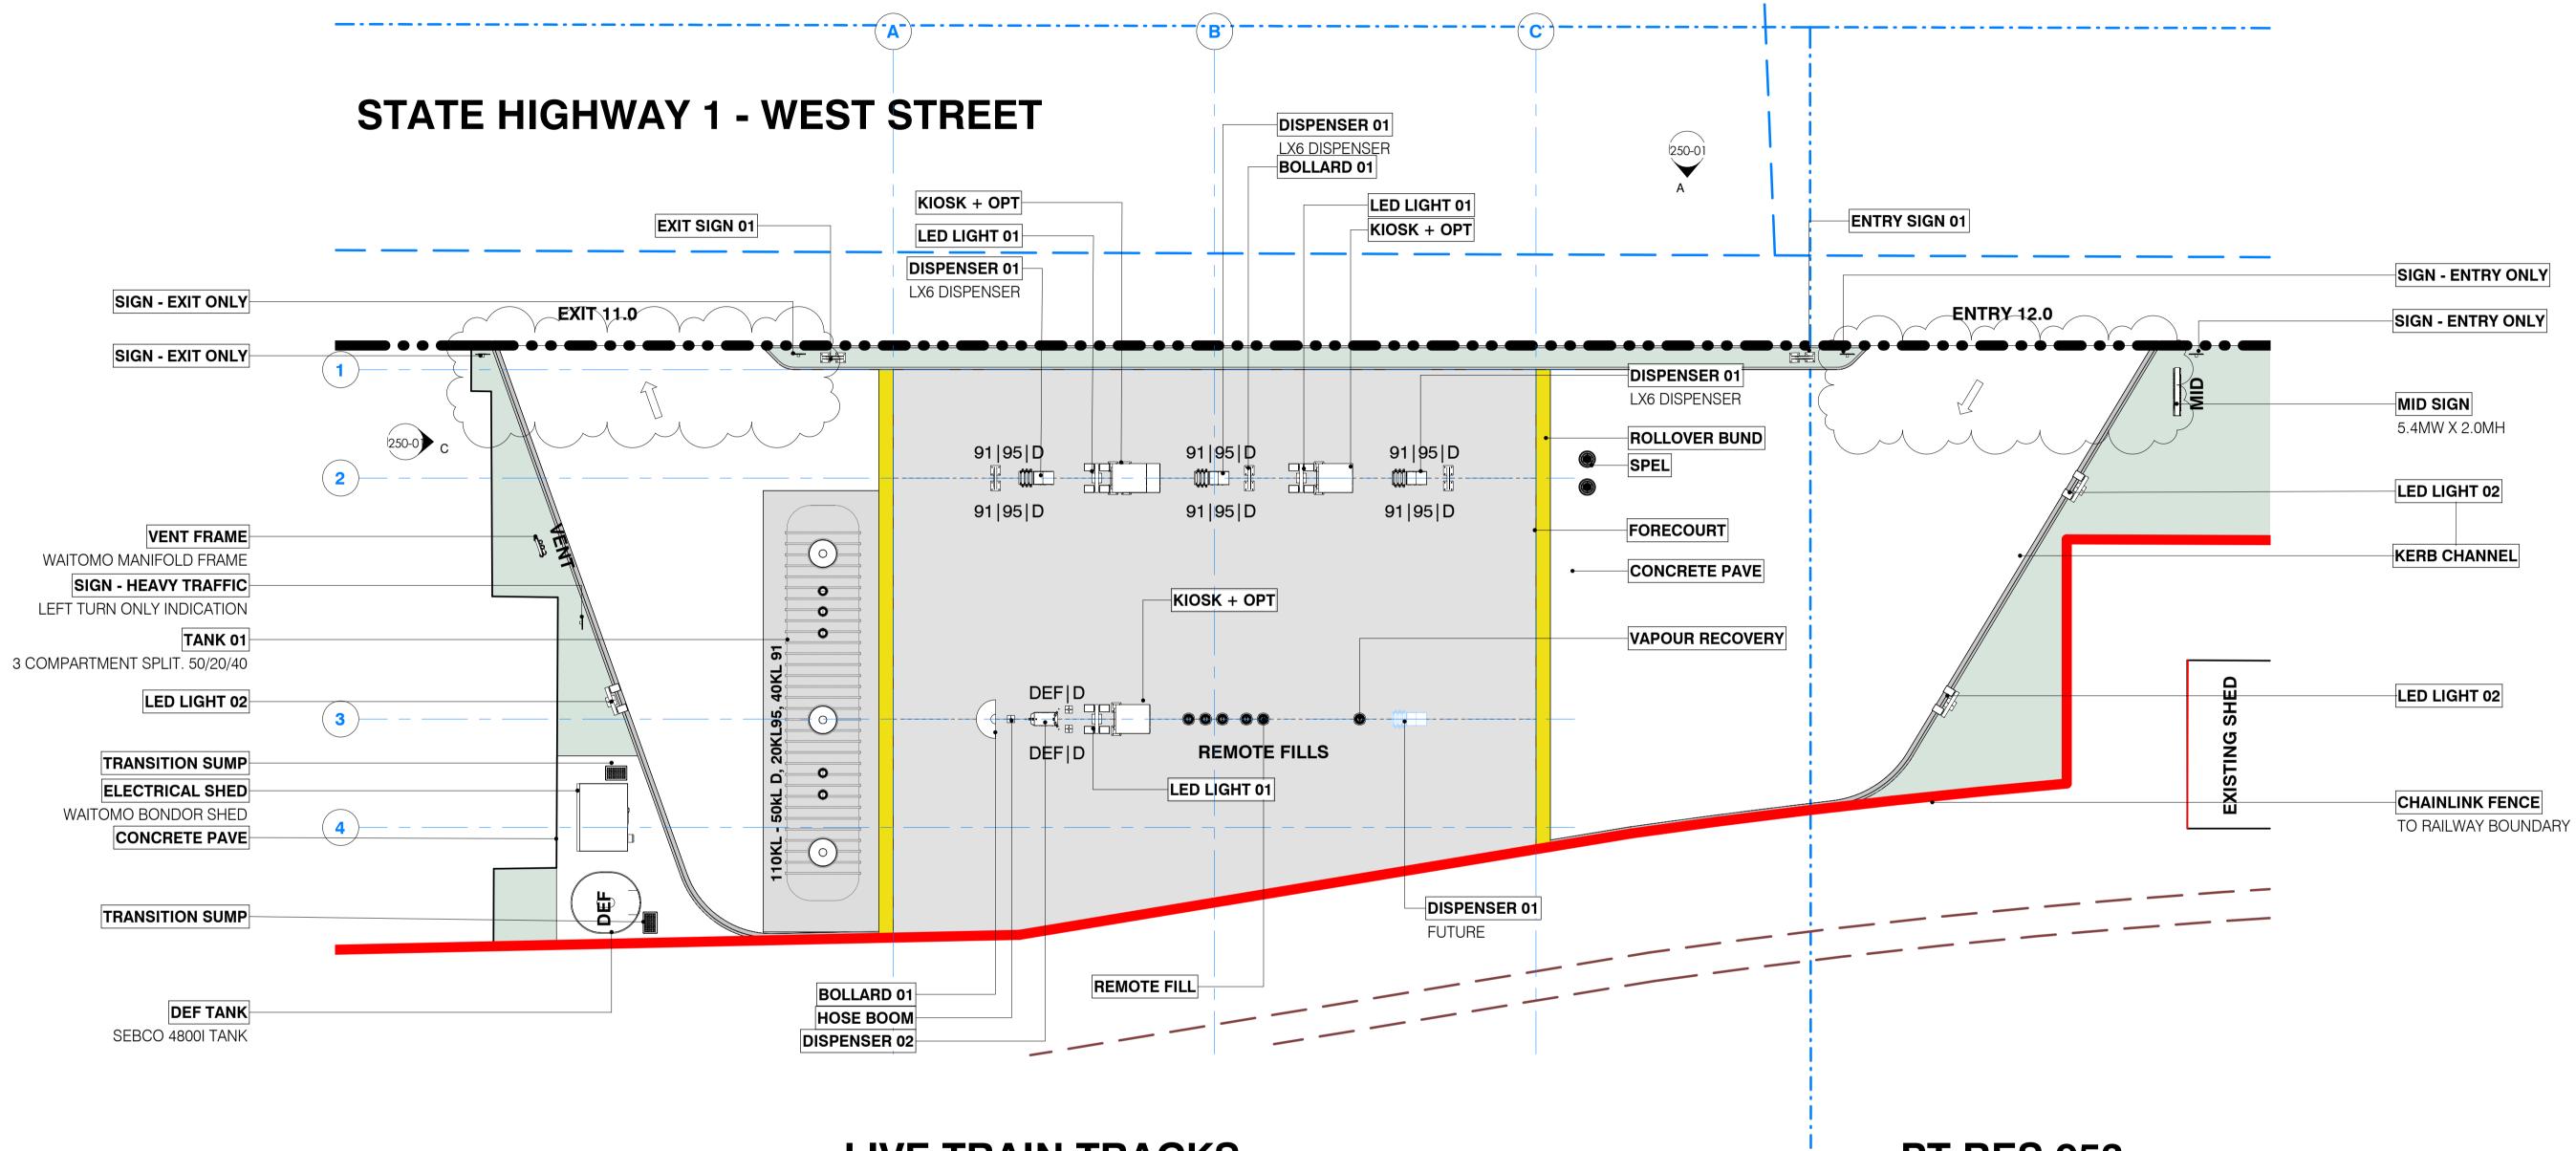


LIVE TRAIN TRACKS


PT RES 953








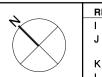

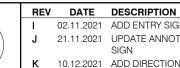

JRTON	DRAWING	SCALE	1:150 ^{@ A1}	PLA	NNING	
1), ASHBURTON	200 GA PLANS PROPOSED PLAN	DATE	13.12.2021	PROJECT NO.	DRW NO. R	REV.
		DRAWN	SHAUN	143	210-02	L
		CHECK	TONY			

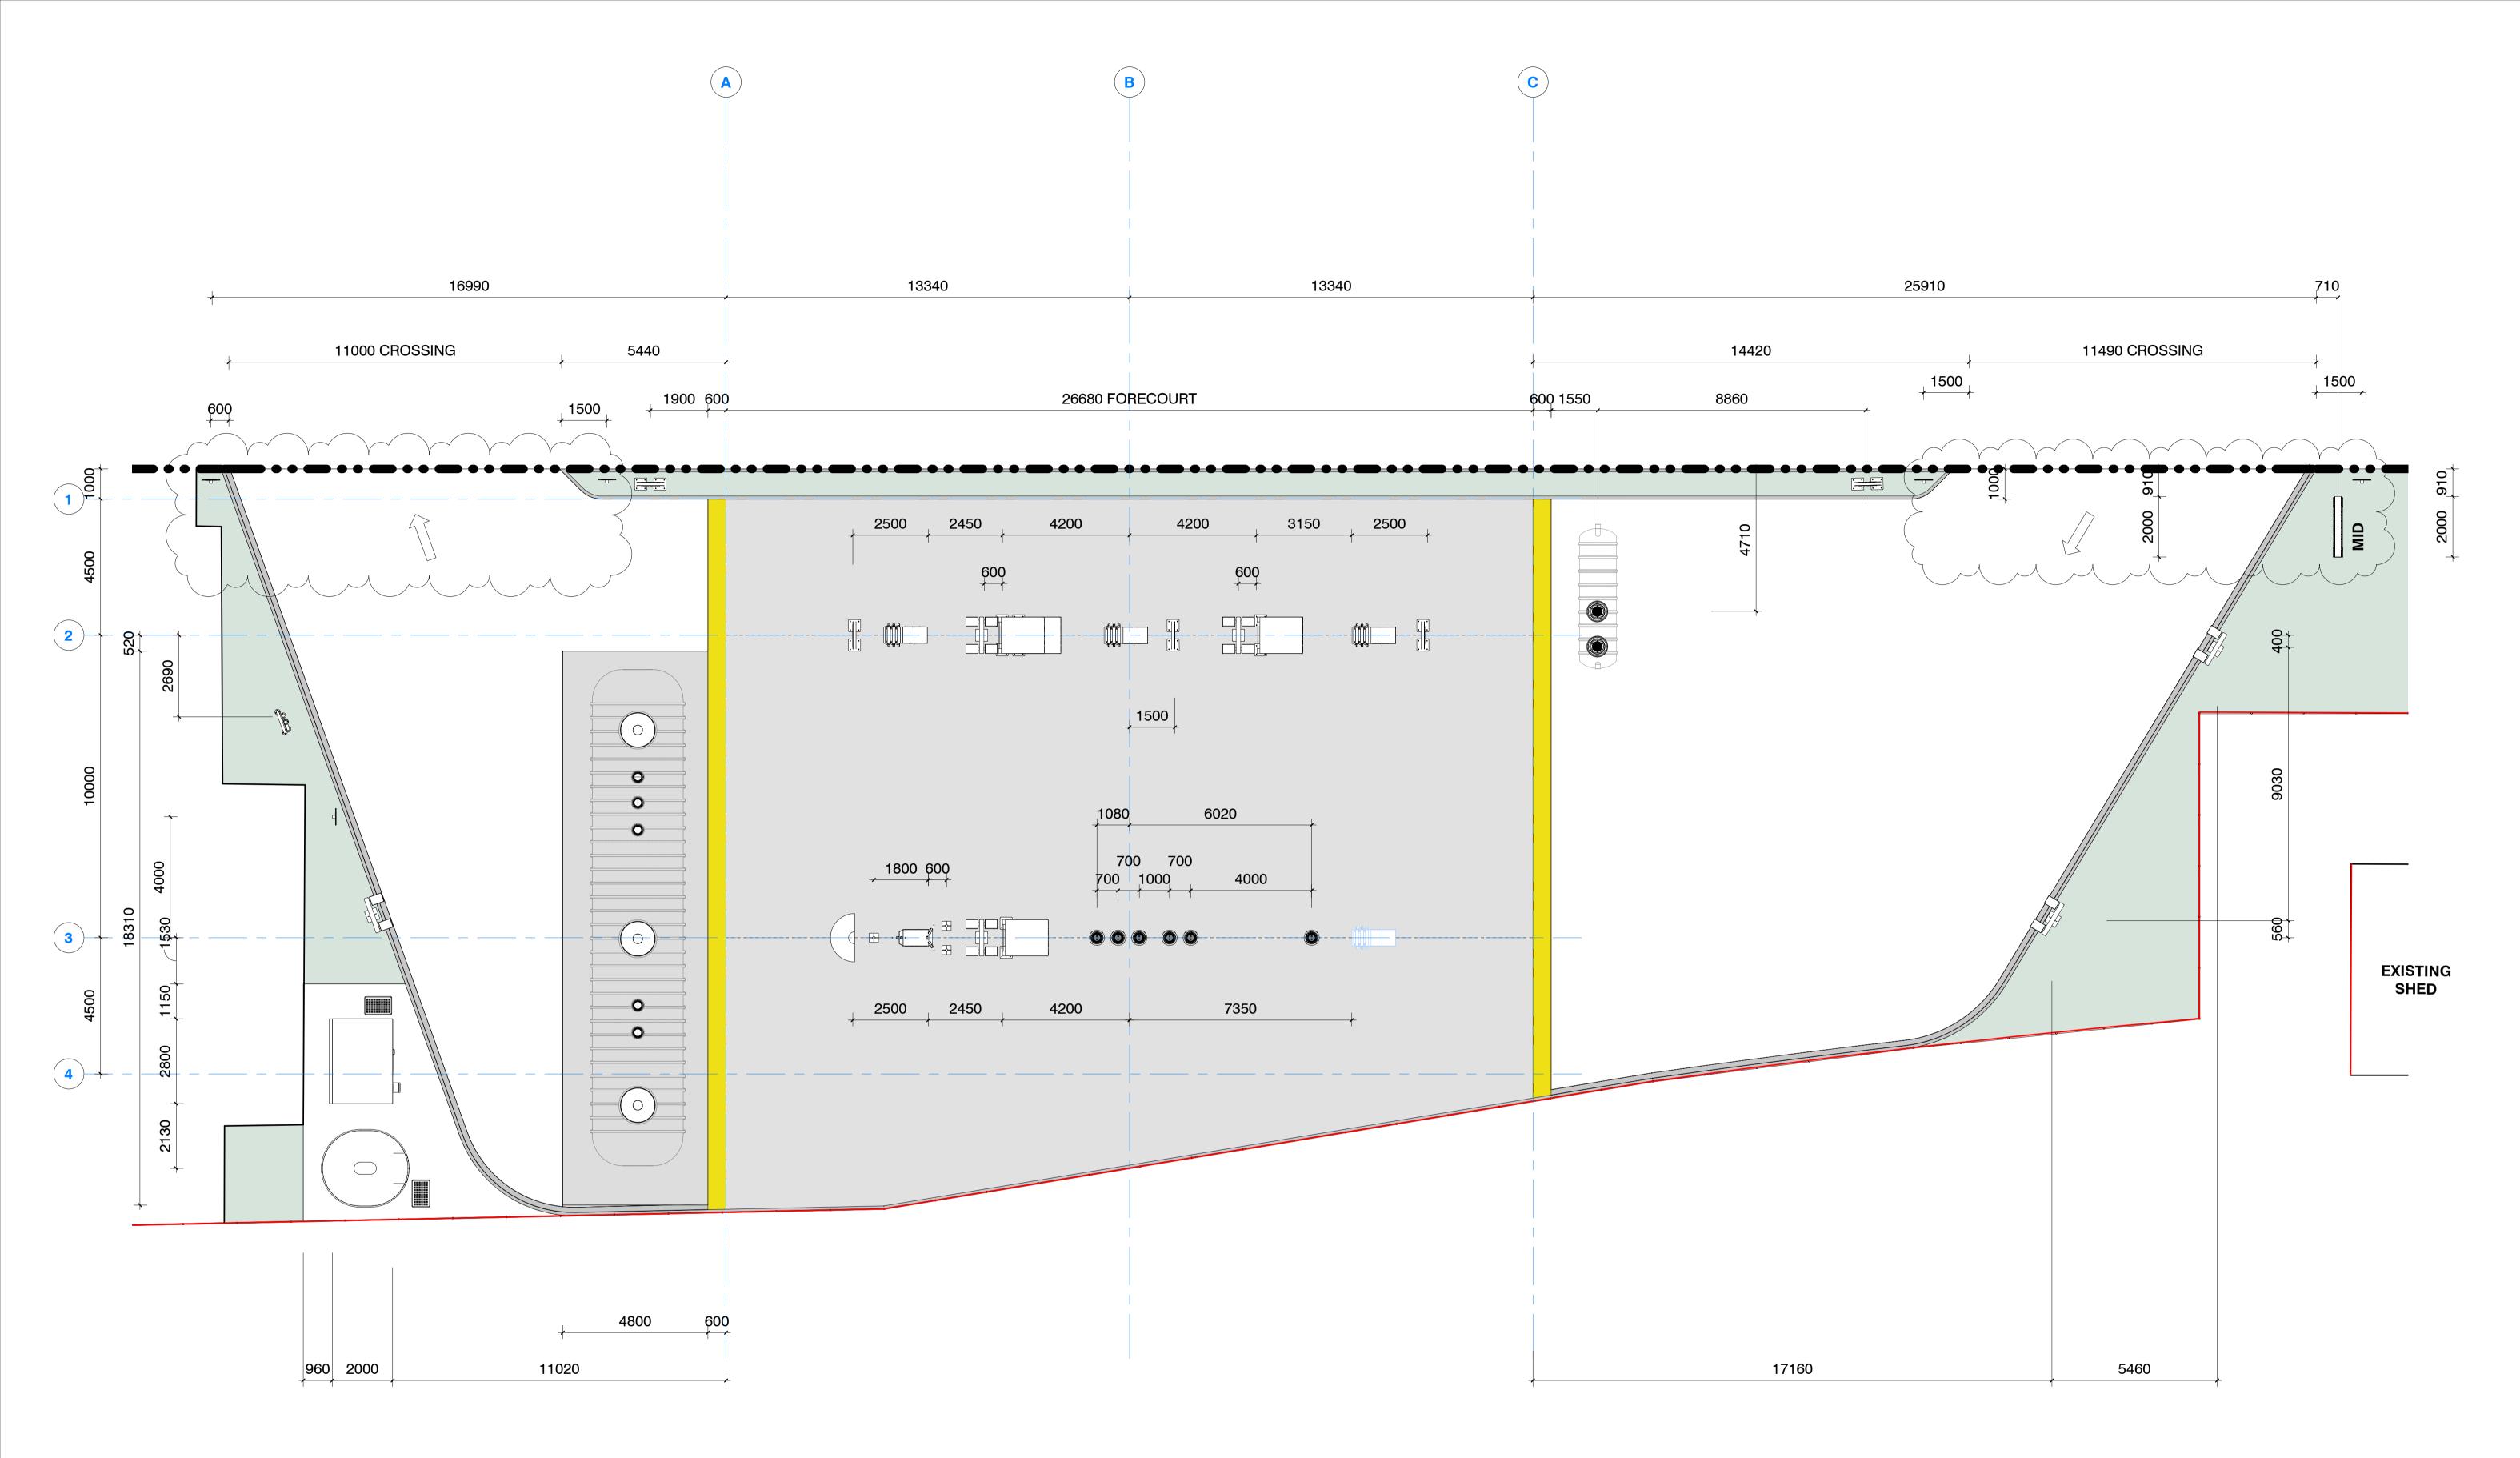





WELLINGTON
P.O Box 45 060CHRISTCHURCH
P.O Box 17 017AUCKLAND
P.O Box 97 310SOLUTIONS
VoltationP.O Box 45 060
Waterloo
Lower HuttP.O Box 17 017
WoolstonP.O Box 97 310
South Auckland
Auckland
ChristchurchTel: 04 567 0877Tel: 03 376 6080
Tel: 09 263 7393



REV DATE DESCRIPTION

 15.09.2021
 RESOURCE CONSENT


 A
 10.12.2021
 ADD DIRECTIONAL ARROWS

 B
 13.12.2021
 UPDATE

WEST STREET (SH1)

PT RES 953

URTON	DRAWING	SCALE	1:100 @ A1 x2 A3	PLA	NNING	
11), ASHBURTON	200 GA PLANS	DATE	13.12.2021	PROJECT NO.	DRW NO.	REV.
	SETOUT PLAN	DRAWN	SHAUN	143	210-03	в
		CHECK	SHAUN			

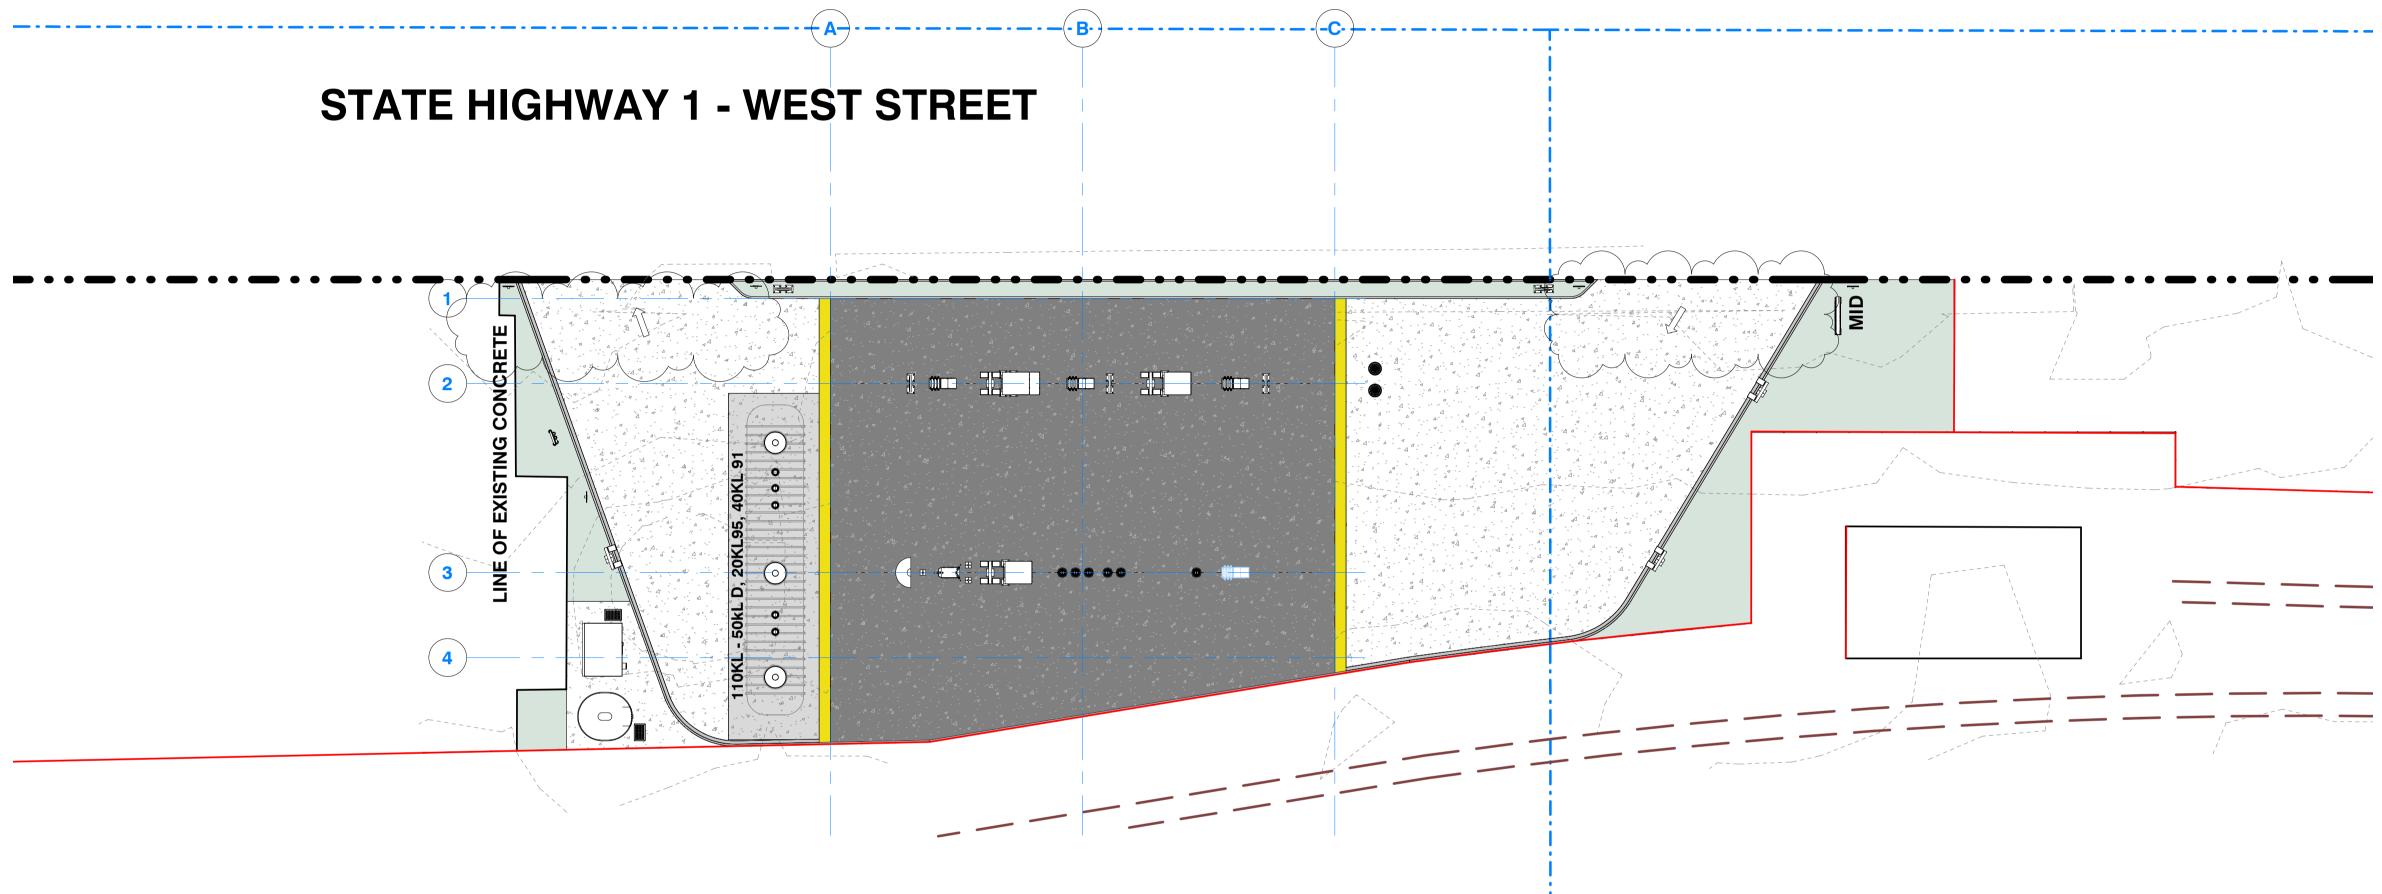

LIVE TRAIN TRACKS

PT RES 953





WELLINGTON
P.O Box 45 060CHRISTCHURCH
P.O Box 17 017AUCKLAND
P.O Box 97 310SOLUTIONS
Voterioo
Lower Hutt
Tel: 04 567 0877P.O Box 17 017
Voolston
Christchurch
Tel: 03 376 6080P.O Box 97 310
South Auckland
Auckland
Tel: 09 263 7393



REV DATE DESCRIPTION

15.09.2021 RESOURCE CONSENT
 A
 10.12.2021
 ADD DIRECTIONAL ARROWS

 B
 13.12.2021
 UPDATE

WAITOMO ASHBUF WEST STREET (SH1)

PAVEMENT LEGEND

GENERIC 150 CONC. PAVE TANK SLAB - 200MMT

FORECOURT - 150MMT

(7% BLACK OXIDE)


/ / ROLL OVER BUND

PERMEABLE SURFACE

----- CONCRETE CUT

SITE SCHEDULE	
PAVEMENT TYPE	AREA
FORECOURT	588 m ²
GENERAL CONCRETE	601 m ²
LANDSCAPING	227 m ²
ROLL OVER	26 m ²
TANKSLAB	175 m ²
Grand total: 12	1618 m ²

URTON	DRAWING	SCALE	1:200 ^{@ A1} ^{x2} A3	PLA	NNING	
I1), ASHBURTON	200 GA PLANS PAVEMENT SURFACES	DATE	13.12.2021	PROJECT NO.	DRW NO.	REV.
		DRAWN	SHAUN	143	210-04	в
		CHECK	SHAUN			

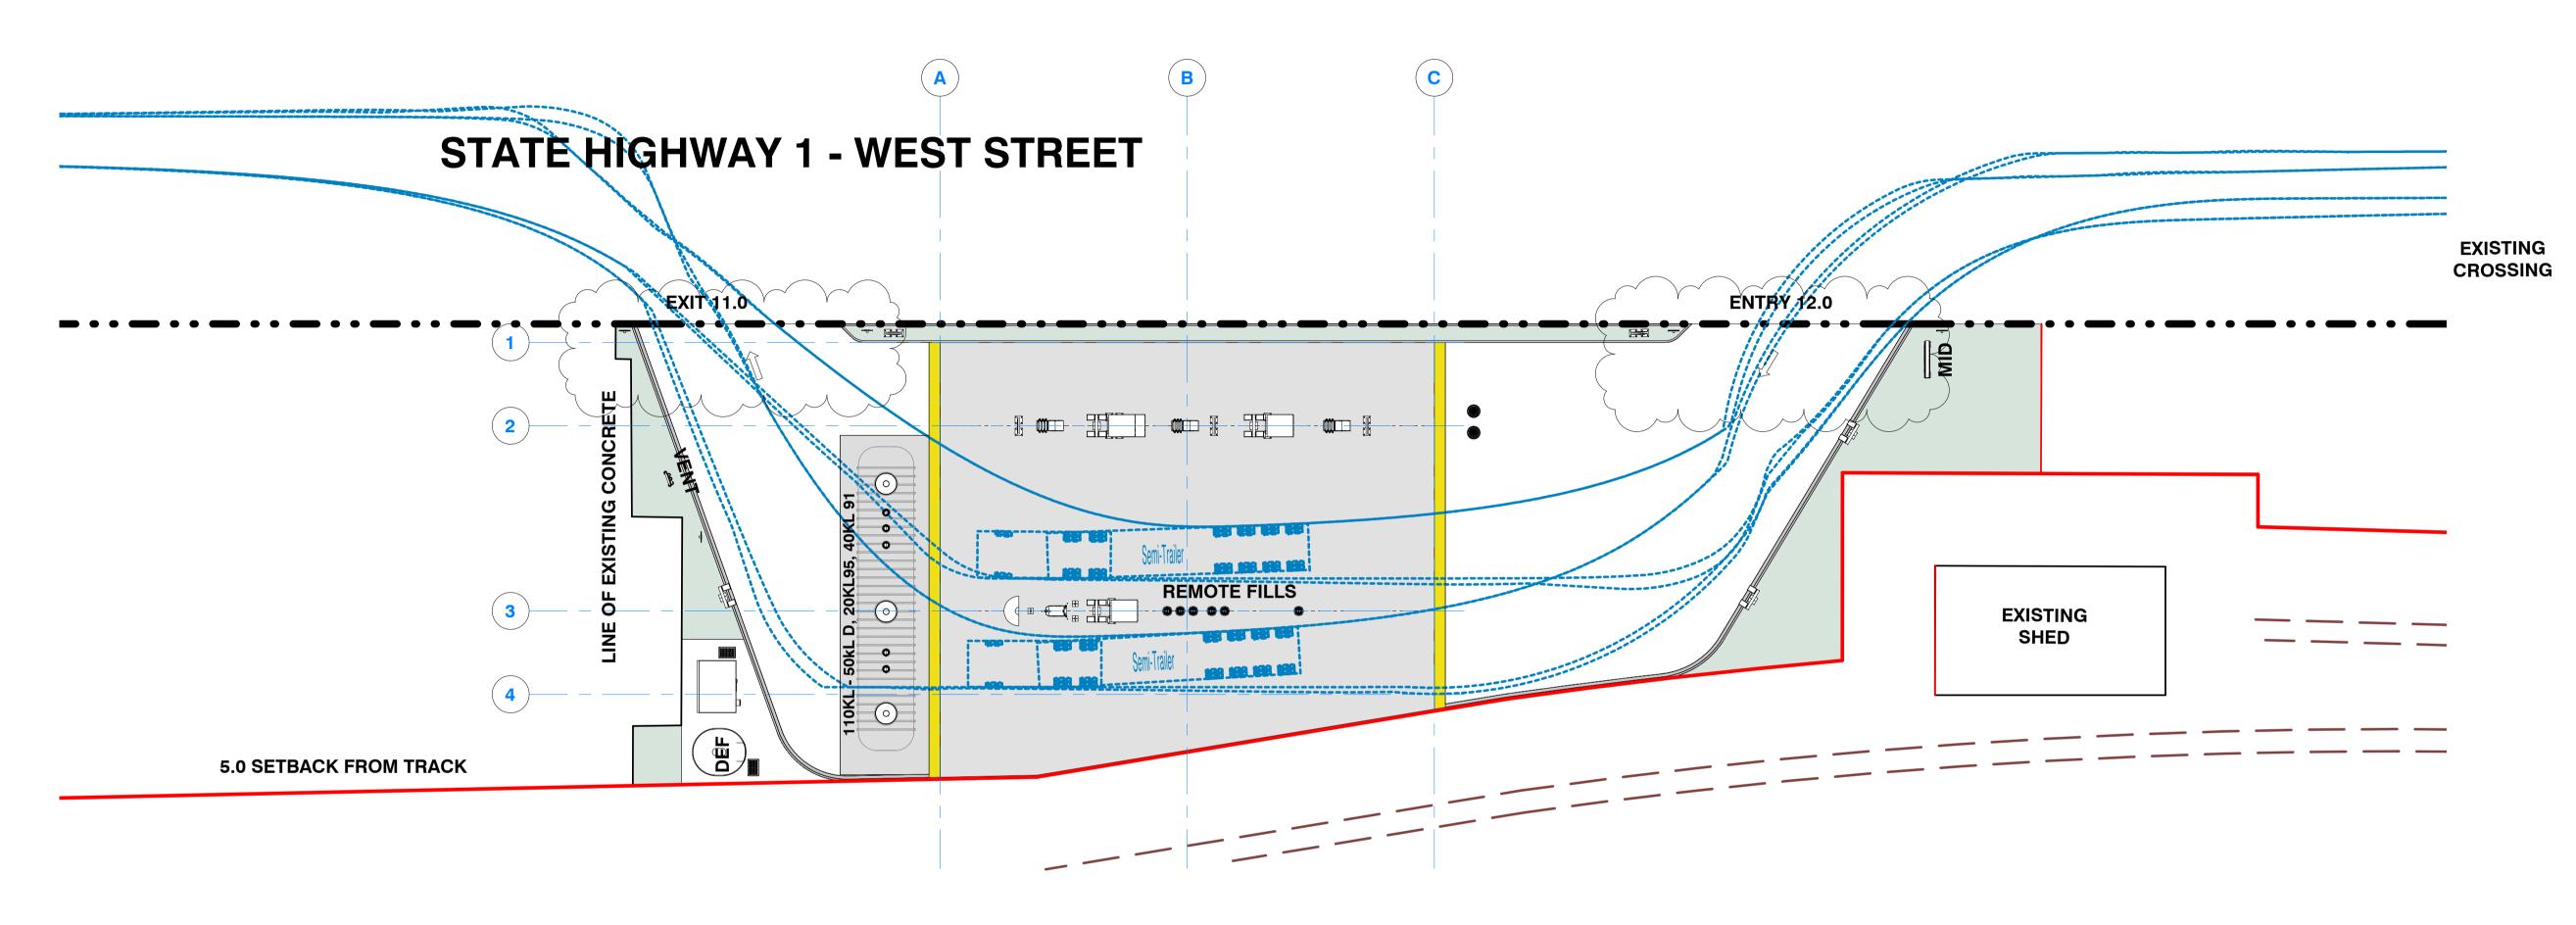

LIVE TRAIN TRACKS


PT RES 953










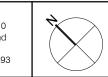


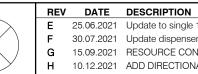

25.06.2021 Update to single 110kl tank. F30.07.2021Update dispenser configurationG15.09.2021RESOURCE CONSENT H 10.12.2021 ADD DIRECTIONAL ARROWS

WEST STREET (SH1)

URTON	DRAWING	SCALE	1:200 ^{@ A1}	PLANNING
I1), ASHBURTON	200 GA PLANS	DATE	13.12.2021	PROJECT NO. DRW NO. REV.
	TANKER PATH	DRAWN	SHAUN	143 210-05 I
		CHECK	SHAUN	

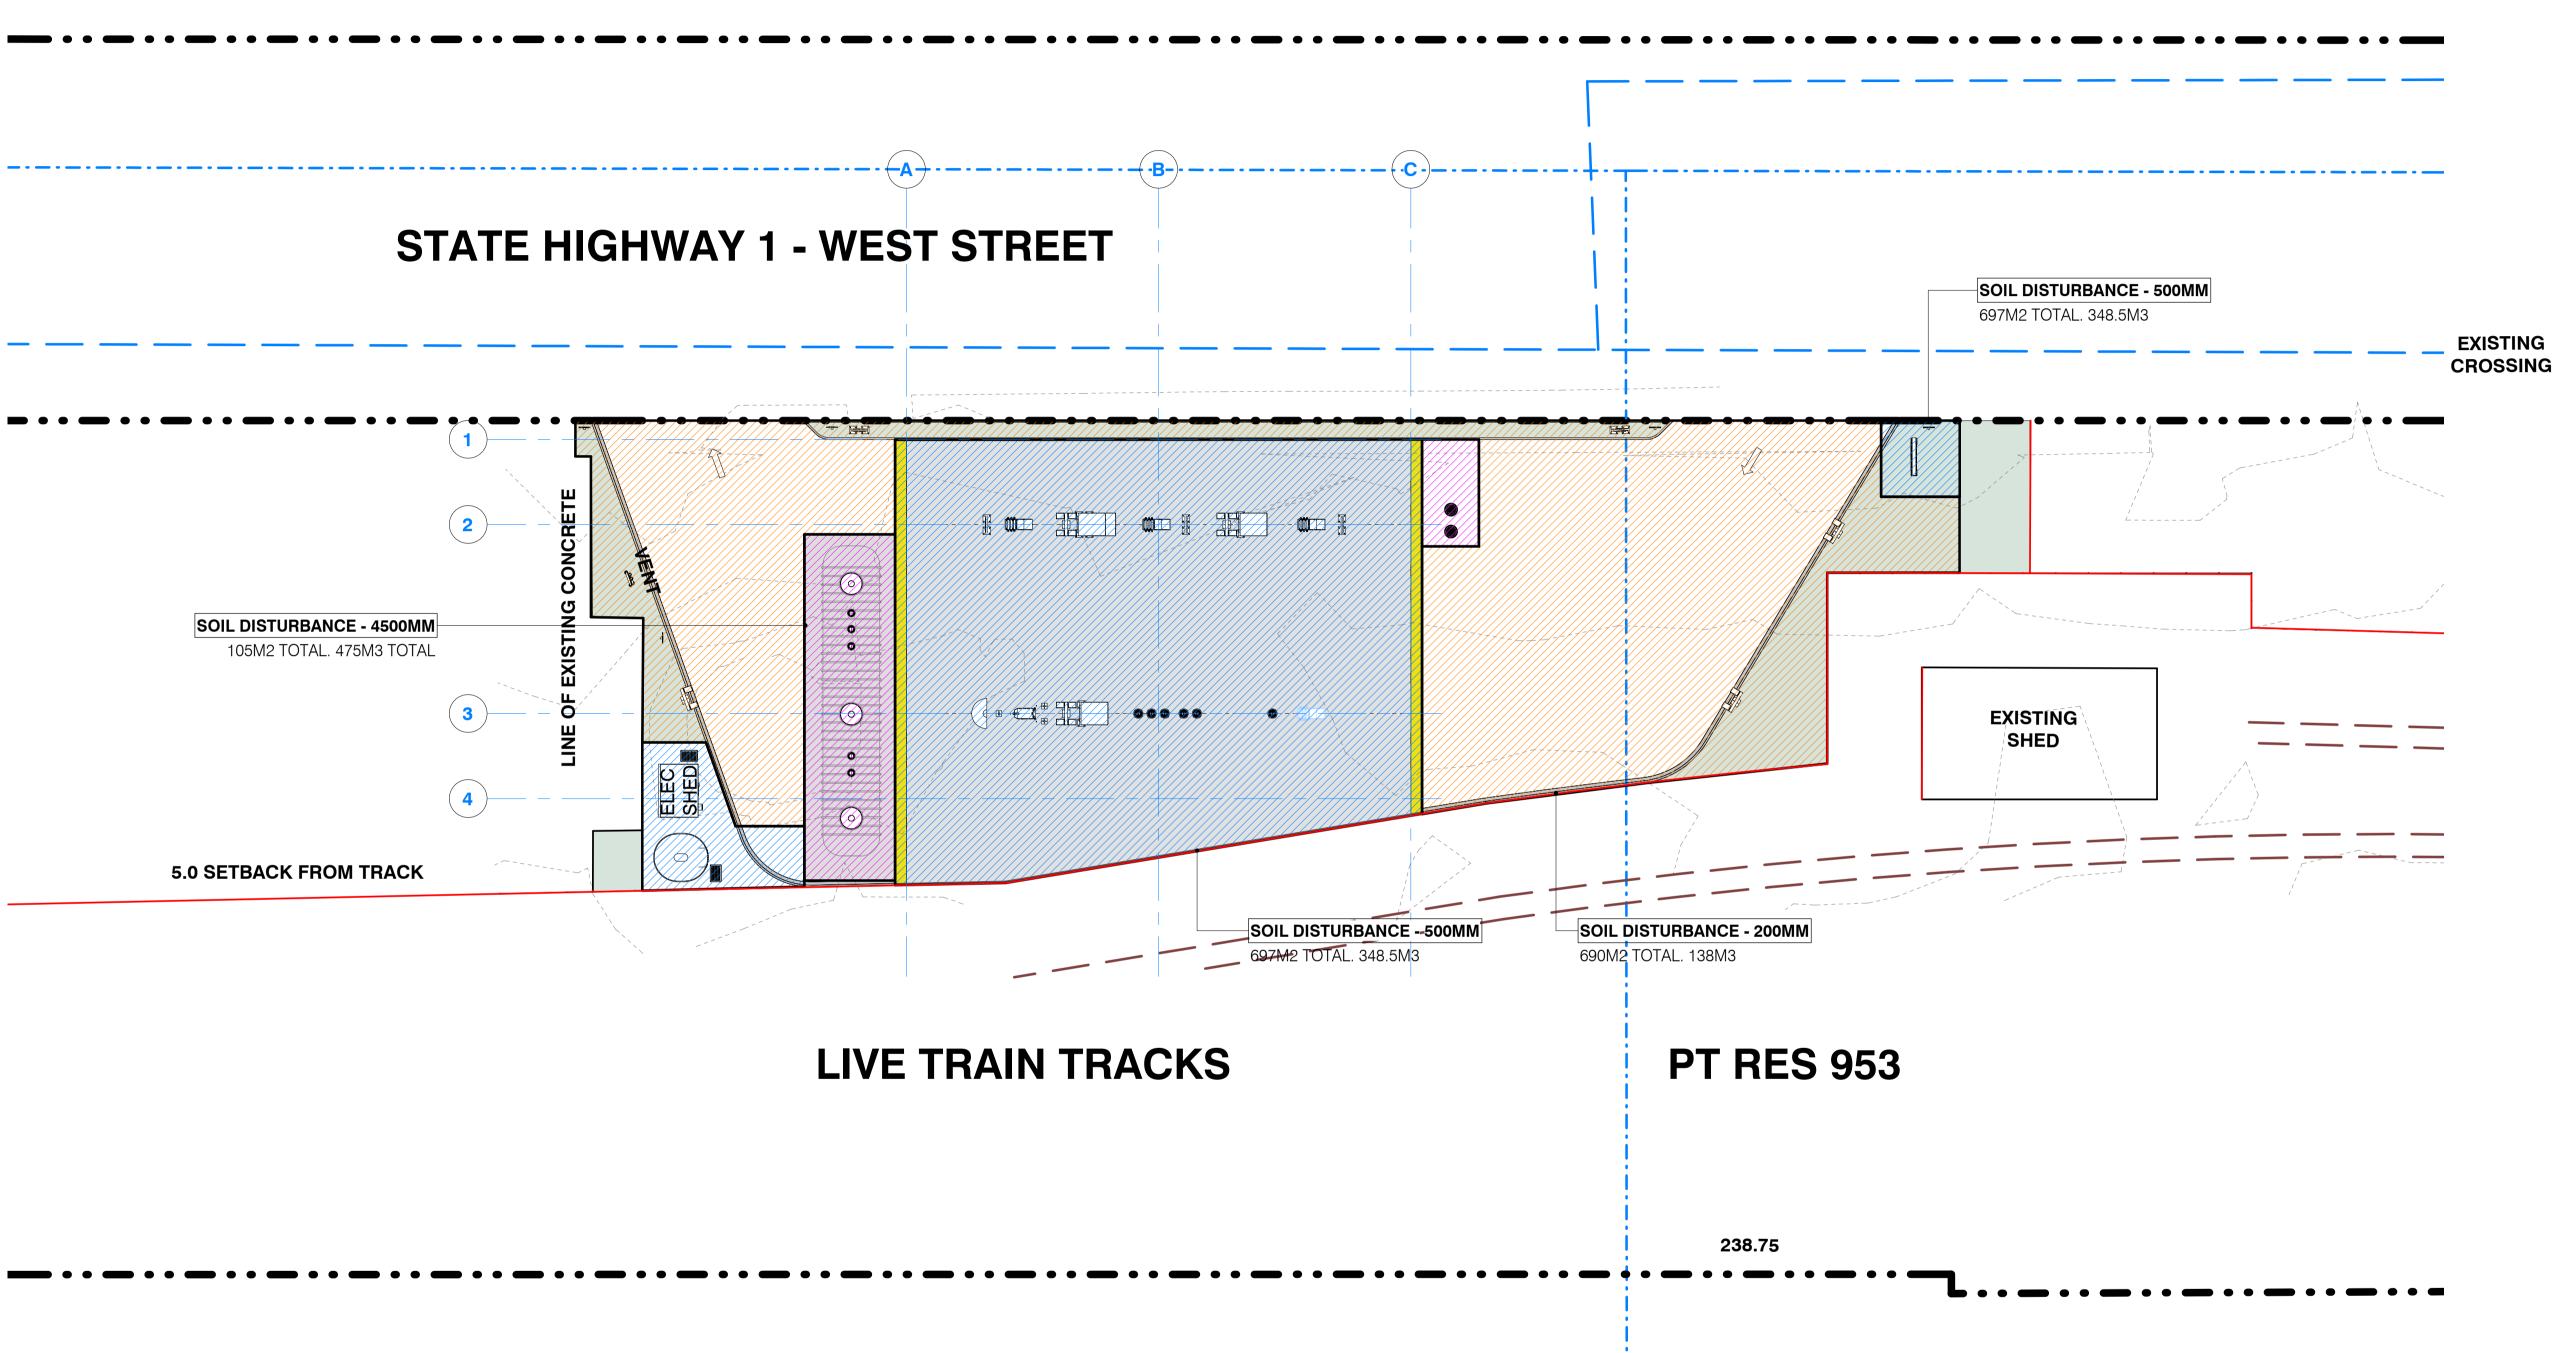








SOIL DISTURBANCE AND INFILL

SOIL DISTURBANCE -EXCAVATION - 200MM EXCAVATION - 500MM

EXCAVATION - 4500M

URTON	DRAWING	SCALE	1:200 ^{@ A1}	PLANNING
11), ASHBURTON	200 GA PLANS	DATE	15.09.2021	PROJECT NO. DRW NO. REV.
	EARTHWORKS PLAN	DRAWN	SHAUN	143 210-07 -
		CHECK	SHAUN	

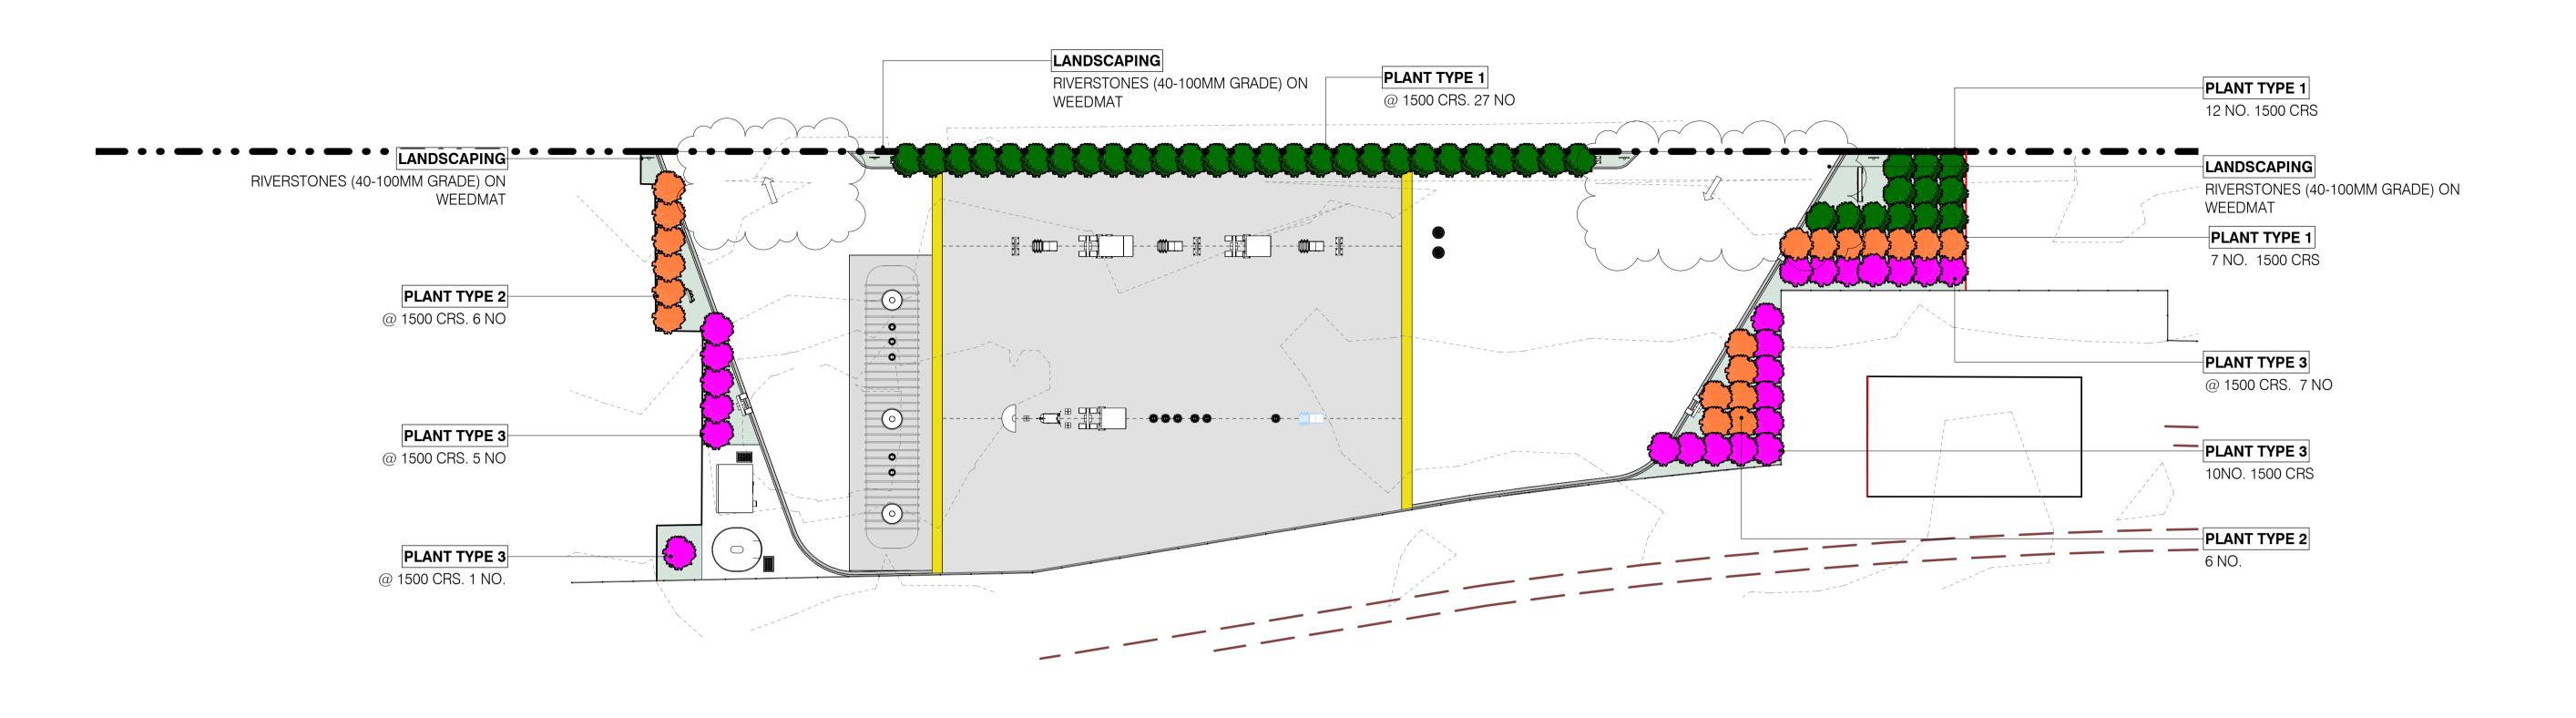

WEED CONTROL

ALL AREA TO PLANT SHALL BE ENTIRELY FREE OF GRASS, PLANT PESTS AND NUISANCE WEED SPECIES. IF HERBICIDE ERADICATION IS REQUIRED THE CONTRACTOR SHALL SUFFICIENTLY SPRAY TO AREA TO REMOVE ALL TREES OVER 2M HEIGHT SHALL BE STAKED VERTICALLY WITH TWO STAKES. TIE TREES AT 2/3 THE SUCH AND NOTIFY THE PROJECT MANAGER OF THE JOB. A REGISTERED SPRAYING CONTRACTOR SHALL BE ONSITE AND CONTROLLING THE SPRAYING OPERATIONS AT ALL TIMES. THEY SHALL BE A REGISTERED CHEMICAL APPLICATOR WITH A CURRENT A AND B CERTIFICATES, OR GROWSAFE EQUIVALENT. SPRAYING ACTIVITIES SHALL MEET THE REQUIREMENTS OF THE CONTROLLING AUTHORITY. HERBICIDE GENERAL: APPLY USING PROTECTIVE CLOTHING. IN DRY. STILL-AIR CONDITIONS TO THE SPRAY MANUFACTURERS REQUIREMENTS. THE CONTRACTOR SHALL BE RESPONSIBLE FOR REINSTATING ANY DAMAGE CAUSED BY DRIFT OF SPRAY.

GARDEN BED PREPARATION

WEEDMAT WHERE EXISTING TOPSOIL IS OF SUFFICIENT DEPTH AND QUALITY, CULTIVATE TO AN EVEN DEPTH OF 300MM TO PRODUCT A FINE TILTH AND AN EVEN SURFACE. WHERE TOPSOIL IS OF A SUBSTANDARD QUALITY OR IS CONTRACTOR SHALL USE A FABRIC SPUN BONDED 80GSM WEEDMAT, SUCH AS 'WEED SAFE PRO''. NON-EXISTENT, IMPORT AND PLACE FIRST CLASS TOPSOIL TO A DEPTH OF 300MM. FINISHED LEVELS SHALL ENSURE ALL WEEDS HAVE BEEN ERADICATED BEFORE INSTALLING. WEEDMAT SHALL BE PLACED ON ALL ALLOW FOR 100MM (THAT INCLUDED FOR 75MM FOR MULCH + 25MM SO FINISHED LEVEL SITS BELOW GARDEN BEDS, PLACED RIGHT TO GARDEN EDGES AND SECURED AS PER MANUFACTURES SURROUNDING HARD SURFACES). FORMED SUBGRADE SHALL NOT HOLD WATER. REQUIREMENTS. SIX MONTHS.

PLANTING

ALL PLANTS SHALL BE HEALTHY AND WITH NO EVIDENCE OF DECLINE OR DAMAGE E.G. DEAD, DYING, OR DISEASE. PLANTING ARE TO BE THOROUGHLY WATERED PRIOR TO PLANTING. THE PLANTING HOLE SHALL BE AVERAGE, WITHIN THE SPECIFIED MAINTENANCE PERIOD. THE FREQUENCY OF VISITS WILL CHANGE TWICE THE SIZE OF THE ROOT BALL WIDTH AND TWICE THE ROOT BALL DEPTH. PLANTING HOLES SHALL BE LOOSENED FOR AT LEAST 75MM EACH SIDE OF AND UNDER THE PLANT PRIOR TO PLANTING.

FERTILISER

AGPRO CONTROLLED RELEASE FERTILISER TABLETS OR APPROVEaD EQUIVALENT MUST BE PLACED CLOSE BUT NOT IN CONTACT WITH THE ROOTS IN THE BOTTOM OF THE PLANTING HOLE.1 TABLET PER ROOT TRAINER OR PB3, 2 TABLETS FOR PB5, 3 TABLETS FOR PLANTS LARGER THAN PB5.

PLANTING LEGEND

PLANT TYPE 1 LOMANDRA TANIKA 0.65M HIGH X 0.6M WIDE



PLANT TYPE 2 HEBE 'WIRI MIST' 1M HIGH X 1M WIDE

STAKES

HEIGHT OF THE MAIN STEM LEAVING ENOUGH PLAY FOR A SMALL AMOUNT OF NATURAL MOVEMENT. ALL STAKES SHALL BE ROUGH SAWN, FREE FROM KNOTS AND WEAKNESSES. SIZE/LENGTH 50MM X 50MM, LENGTH TO SUIT TREE SIZE.. H4 TREATED TIMBER. TIES SHALL BE 40MM WIDE FLEXIBLE RUBBER TIES. OR OTHER SUCH MATERIAL THAT NOT CAUSE ABRASION TO THE TREE.

WATERING

EACH PLANT SHALL BE THOROUGHLY WATERED AFTER PLANTING, ENSURING THAT THE MOISTURE HAS PENETRATED TO THE FULL DEPTH OF THE ROOTBALL.

MAINTENANCE:

FOLLOWING THE DATE OF ISSUE OF THE PRACTICAL COMPLETION CERTIFICATE. THE MAINTENANCE PERIOD SHALL BE 12 MONTHS FOR ALL GRASSED, MULCHED AND PLANTED AREAS. THE CONTRACTOR SHALL ALLOW FOR A MINIMUM OF 12 MAINTENANCE VISITS; BEING ONE VISIT EVERY 4 WEEKS ON RELATIVE TO SEASONAL DEMAND OF WEED CONTROL WITHIN THE MAINTENANCE PERIOD.

WORKS SHALL INCLUDE

MANUAL WATERING; WATERING BY WATER TRUCK OR BY HAND UTILISING AN ONSITE SUPPLY PROVIDED BY THE DEVELOPER. VISITS SHALL BE SUFFICIENT TO ENSURE THE SUCCESS OF THE PLANTS OVER THE ESTABLISHMENT PERIOD.



WEED CONTROL: TO KEEP PLANTED AREAS WEED FREE, WEED ERADICATION SHALL COMPLY WITH THE SPRAYING REQUIREMENTS OF THIS SPECIFICATION

MAINTENANCE OF BARK MULCH: TO BE MAINTAINED AT A DEPTH OF 75MM.

MAINTENANCE OF GRASS AREA: WITHIN TWO MONTHS OF SOWING THE GRASS SHALL BE EVENLY DISTRIBUTED ACROSS THE LAWN WITH AT LEAST 95% OF THE GROUND SURFACE COVERED WITH NO BARE PATCHES GREATER THAN 30MM IN DIAMETER.


CONTROL OF PESTS AND DISEASES, REMOVAL OF LITTER, CHECKING OF STAKES AND TIES, TRIMMING, PRUNING OR MOWING AND OTHER ACCEPTED HORTICULTURAL OPERATIONS NECESSARY TO ENSURE NORMAL AND HEALTHY LANDSCAPE ESTABLISHMENT AND GROWTH.

REPLACEMENT OF PLANTS: AN INSPECTION WILL BE HELD THREE WEEKS PRIOR TO THE END OF THE MAINTENANCE PERIOD. ALL PLANTS DEEMED BY THE PROJECT MANAGER/ARCHITECT AS DEAD, DEFECTIVE OR UNHEALTHY ARE TO BE REMOVED AND REPLACEMENTS SUPPLIED AND PLANTED AT THE CONTRACTOR'S EXPENSE, WITHIN THREE WEEKS OF THE INSPECTION DATE. WHERE IT IS IDENTIFIED THAT DEATH IS DUE TO CONTRACTORS SPRAYING OF HERBICIDE. REPLACEMENT WILL BE AT CONTRACTOR'S EXPENSE.


ESTABLISHMENT RATES REQUIRED AT THE END OF THE MAINTENANCE PERIOD ARE 100% FOR ALL TREES (PB95, PB150) AND 95% FOR SMALLER GRADE PLANTS (RT, PB3, PB5, PB6.5).

PLANTS DAMAGED BY WILFUL VANDALISM OR LOST BY THEFT SHALL BE REPLACED AT THE EXPENSE OF WAITOMO. ALL REPLACEMENT PLANTS SHALL BE TO THE SAME GRADE ORIGINALLY PLANTED, AND BE THE SAME SPECIES AND POSITION AS THE REMOVED PLANT, UNLESS OTHERWISE STATED. REPLACEMENT PLANTS SHALL BE MAINTAINED



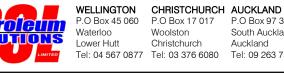


P.O Box 45 060 P.O Box 17 017 P.O Box 97 310 South Auckland Woolston Christchurch Auckland Tel: 04 567 0877 Tel: 03 376 6080 Tel: 09 263 7393

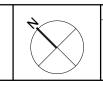

REV DATE DESCRIPTION 02.11.2021 ADD ENTRY SIGN B 29.11.2021 UPDATE LANDSCAPE PLAN. ADD SIGHT LINES C 10.12.2021 ADD DIRECTIONAL ARROWS


WAITOMO ASHBU WEST STREET (SH1)

URTON	DRAWING	SCALE	As indicated	PLA	NNING	
11), ASHBURTON	200 GA PLANS	DATE	13.12.2021	PROJECT NO.	DRW NO.	REV.
	LANDSCAPE PLAN	DRAWN	SHAUN	143	210-08	D
		CHECK	SHAUN			

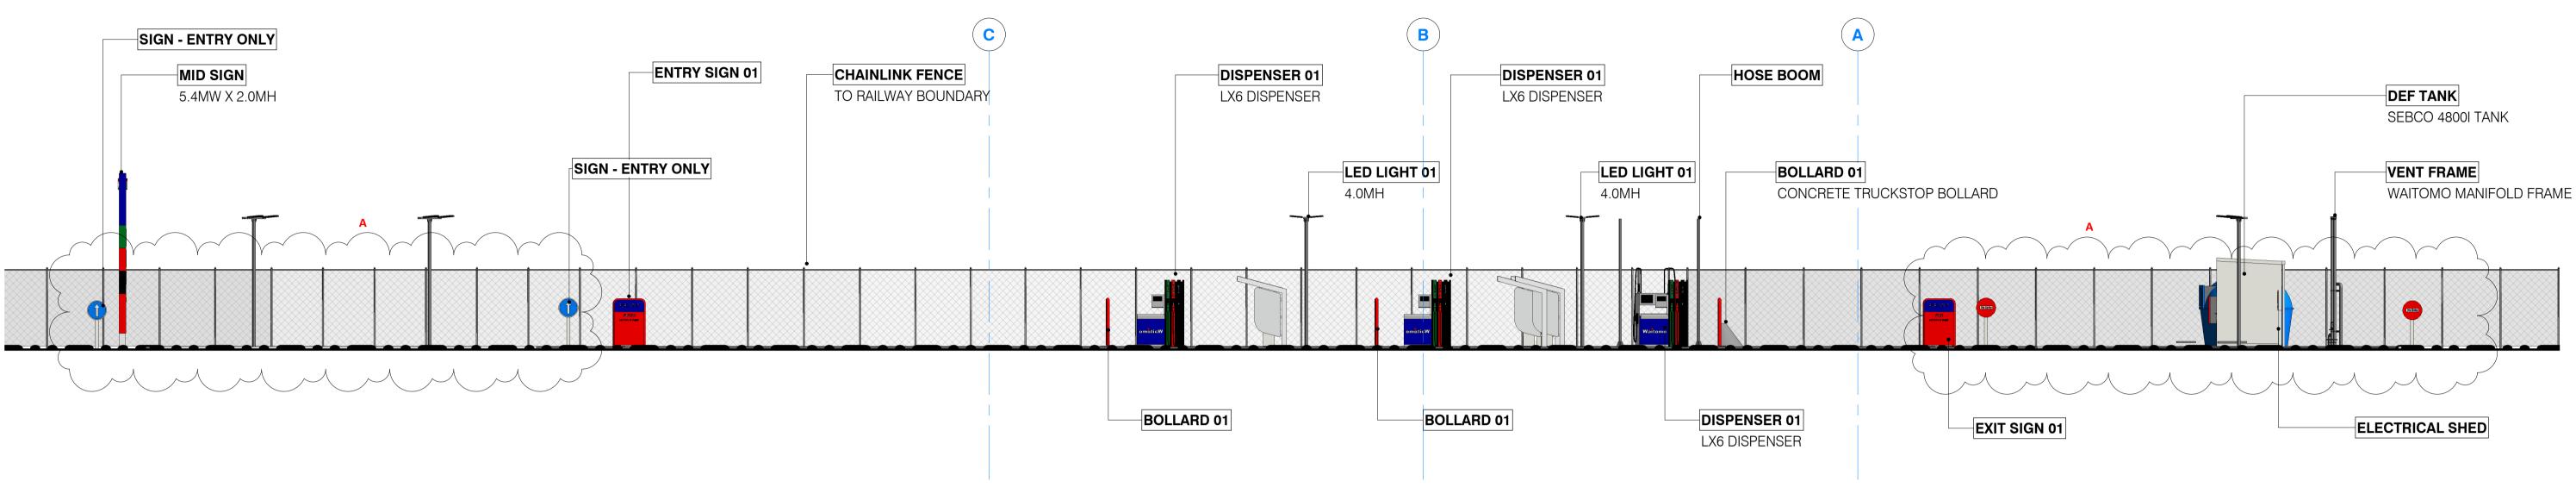



A ELEVATION - SH1 WEST STREET

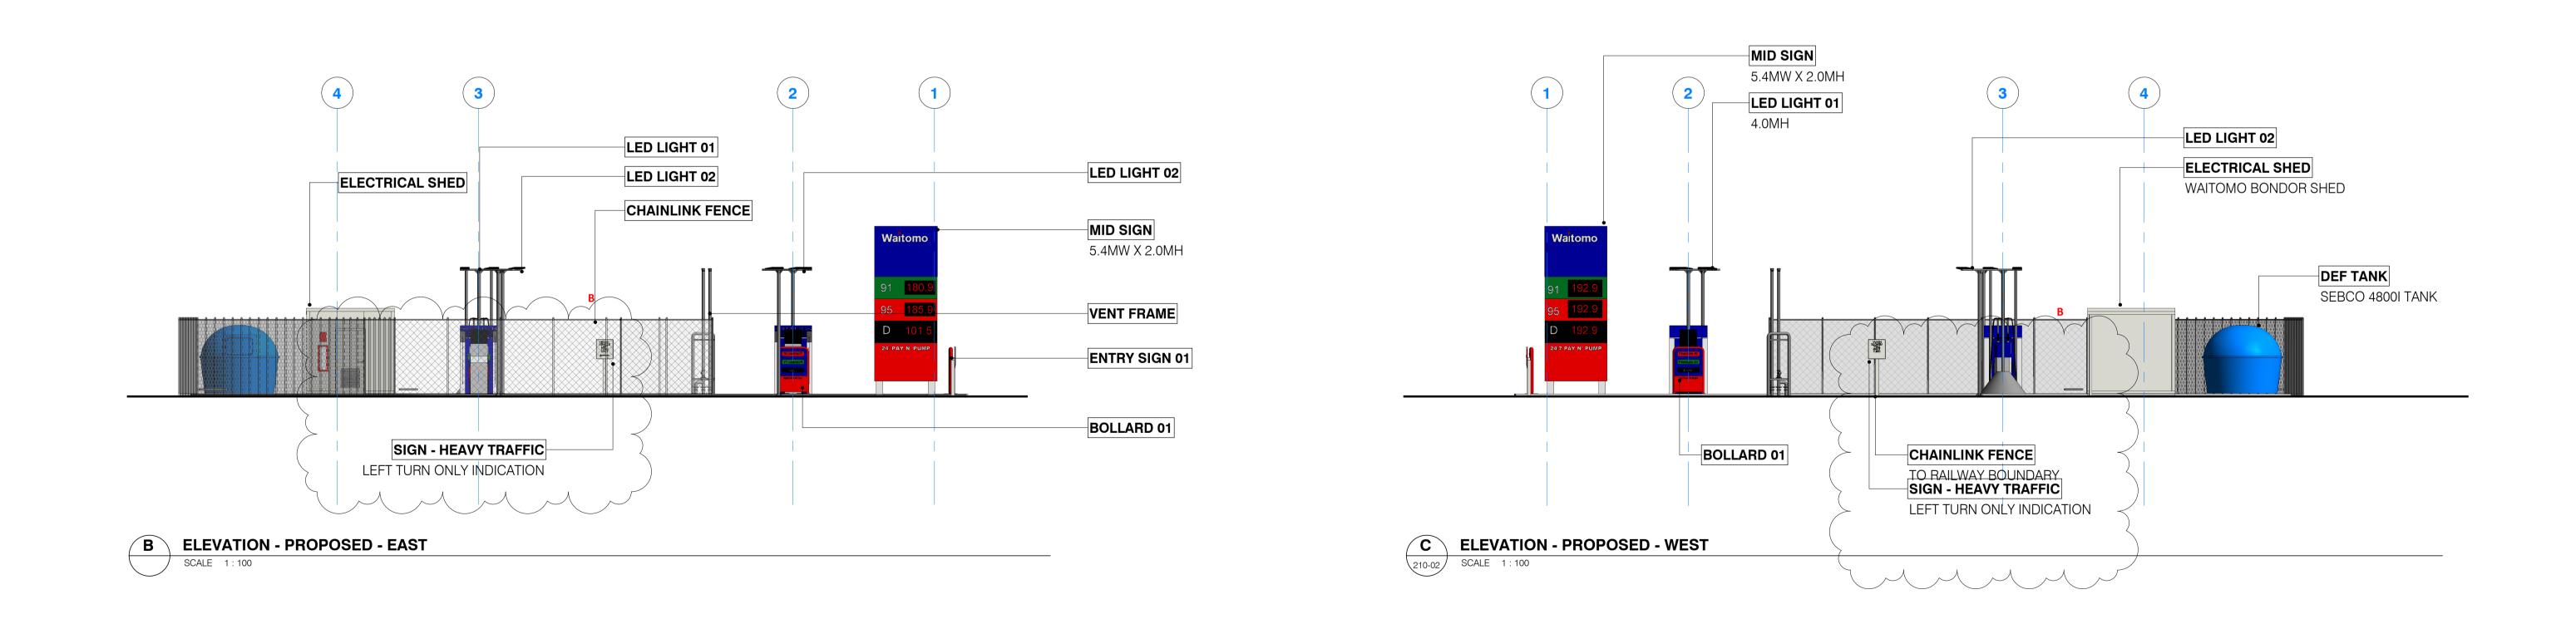






WELLINGTON
P.O Box 45 060CHRISTCHURCH
P.O Box 17 017AUCKLAND
P.O Box 97 310SOLUTIONS
Vaterioo
Lower HuttP.O Box 17 017
Vaterioo
Lower HuttP.O Box 17 017
VoolstonP.O Box 97 310
South Auckland
Auckland
Auckland
Tel: 04 567 0877

REV DATE DESCRIPTION

15.09.2021 RESOURCE CONSENT A02.11.2021ADD ENTRY SIGNB21.11.2021UPDATE ANNOTATION ON
SIGN WAITOMO ASHBUF WEST STREET (SH1)

URTON	DRAWING	SCALE	1:100 ^{@ A1}	PLANNING	
I1), ASHBURTON	200 GA PLANS ELEVATION SHEET 01	DATE	21.11.2021	PROJECT NO. DRW NO. RE	EV.
		DRAWN	SHAUN	143 250-01	в
		CHECK	SHAUN		

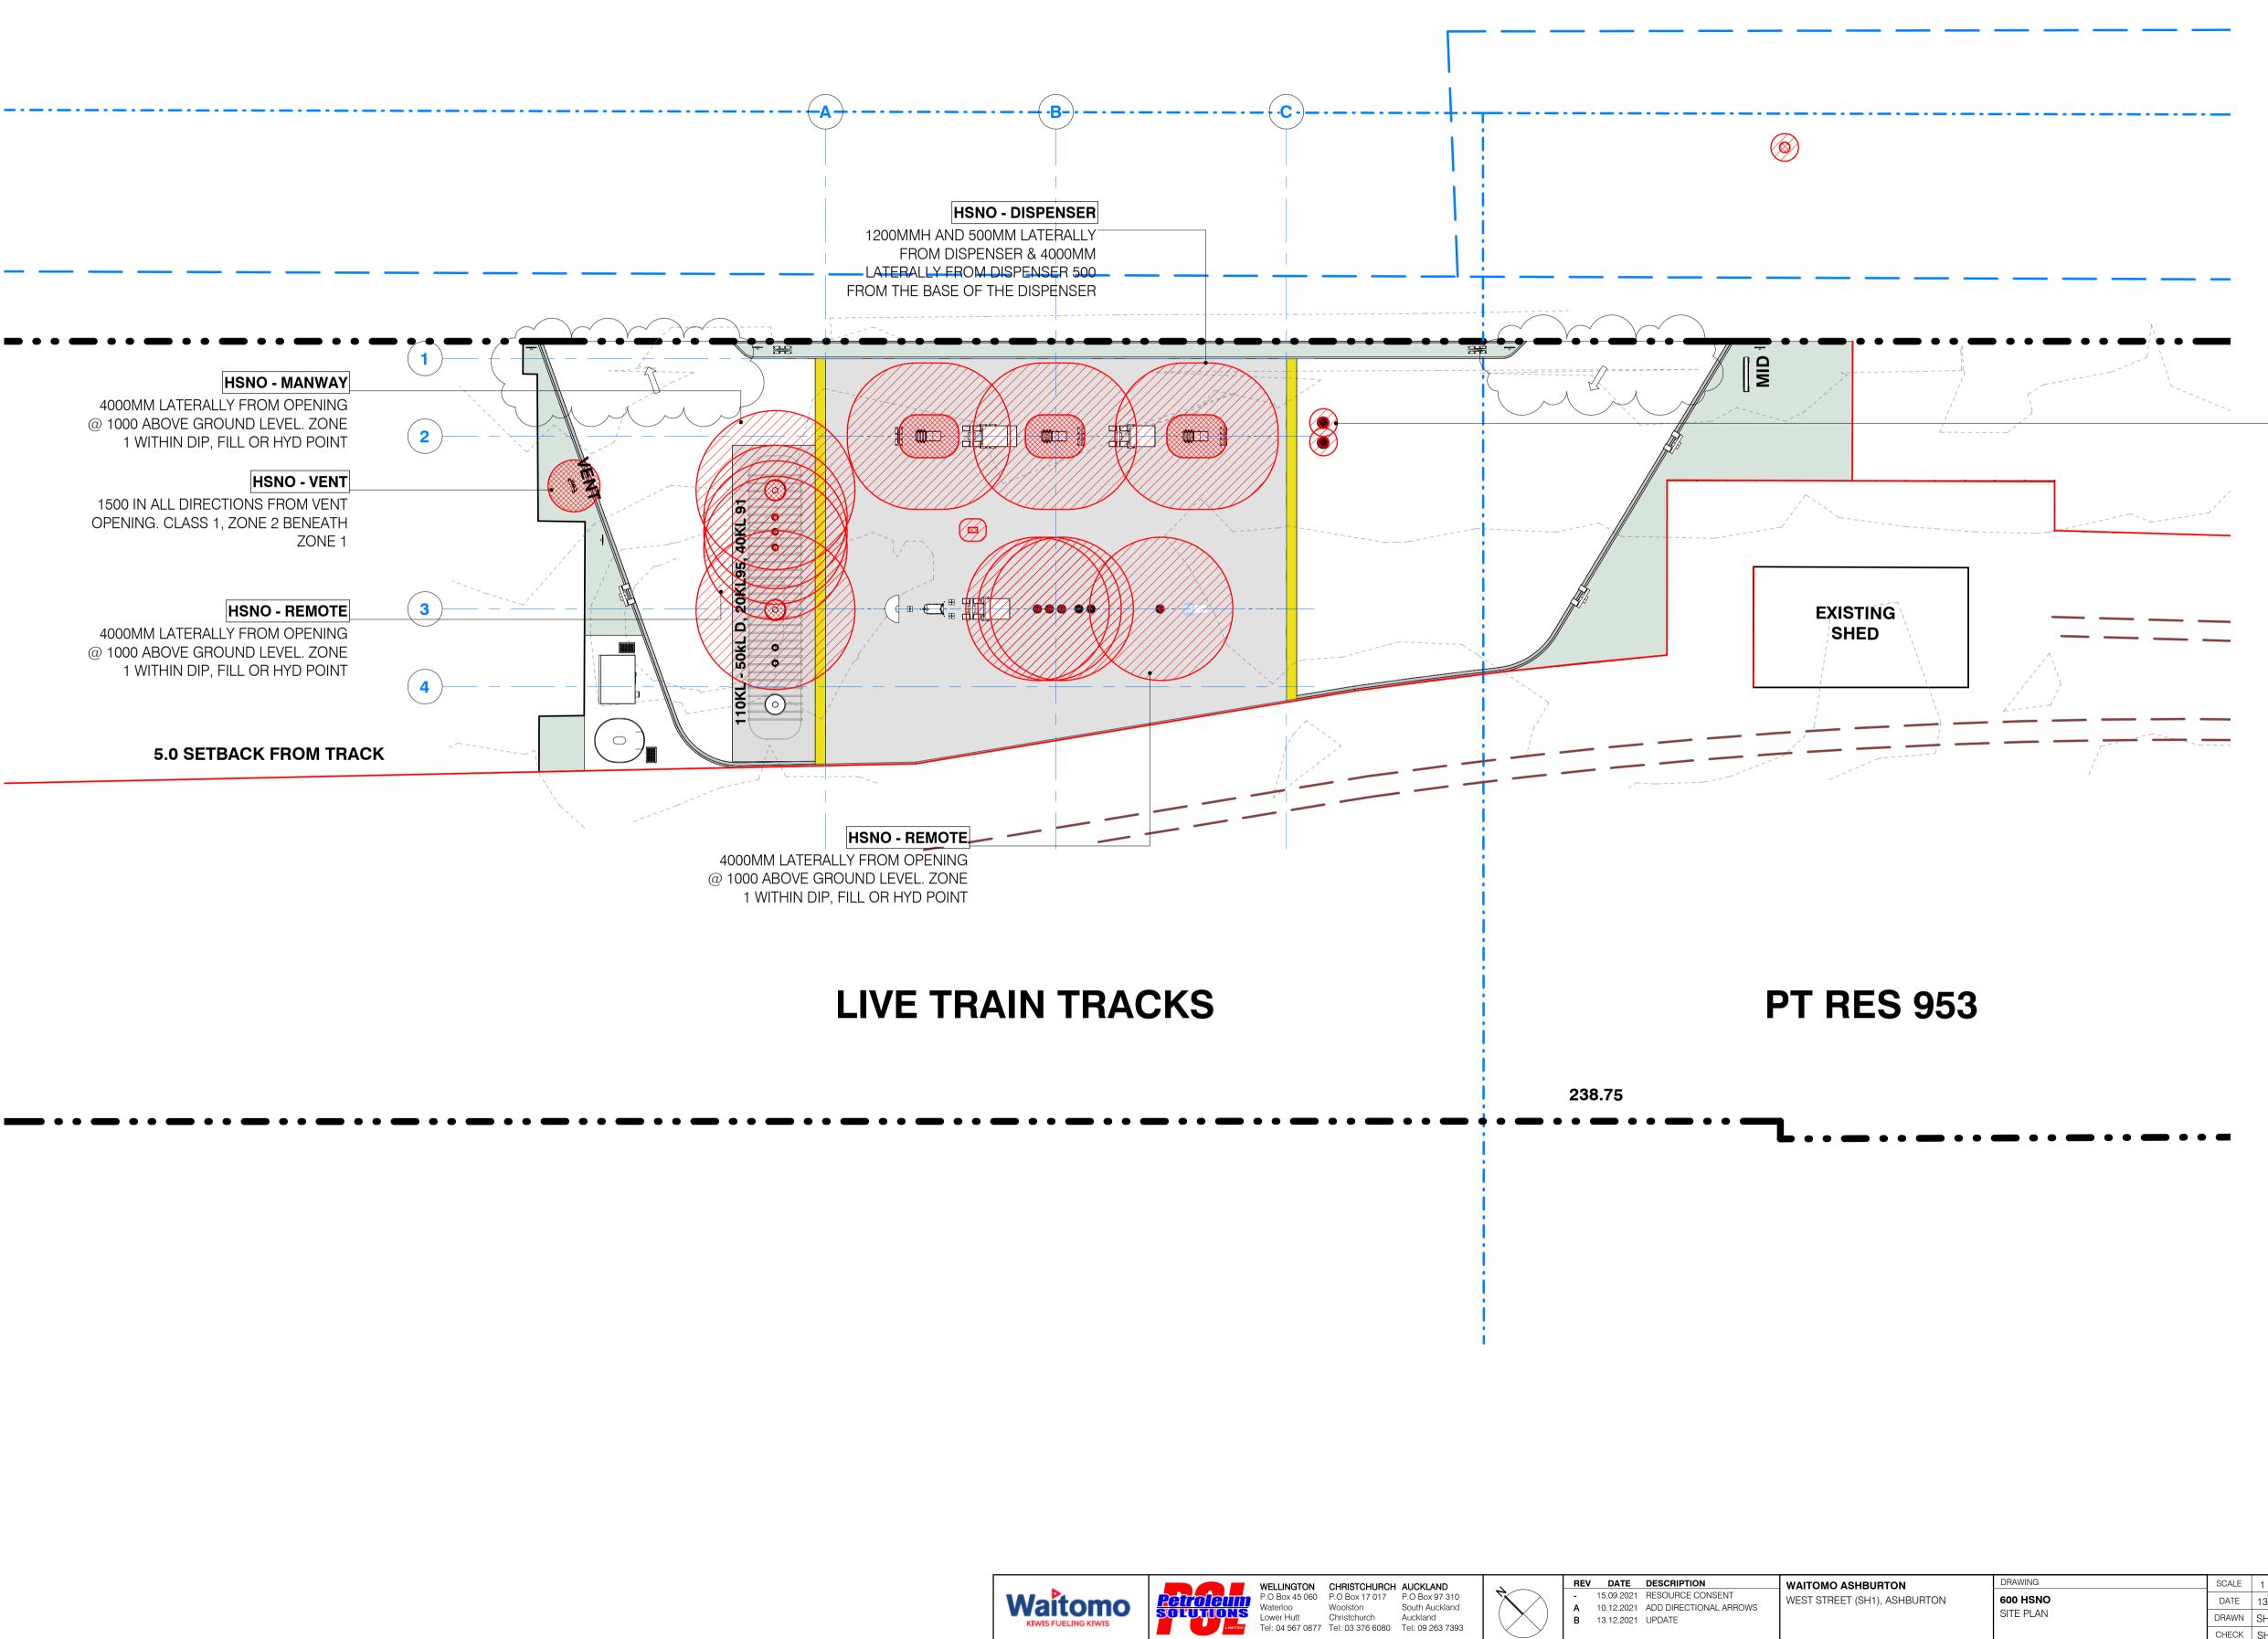

Waitomo

STATE HIGHWAY 1 - WEST STREET

HAZARDOUS ZONE LEGEND

CLASS 1 ZONE 2 CLASS 1 ZONE 1

HSNO - MANHOLE CLASS 1 ZONE 1 IN MANHOLE. CLASS 1 ZONE 2500MMW X 300MMH

15.09.2021 RESOURCE CONSENT

A 10.12.2021 ADD DIRECTIONAL ARROWS

B 13.12.2021 UPDATE


	WAITOMO ASHBURTON WEST STREET (SH1), ASHBURTON	DRAWING 600 HSNO SITE PLAN	SCALE	1:200 ^{@ A1}	PLA	NNING	
W			DATE	13.12.2021	PROJECT NO.	DRW NO.	REV.
			DRAWN	SHAUN	143	610-01	в
			CHECK	SHAUN			





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•		•		
-			1	-

URTON	DRAWING	SCALE	1:500 ^{@ A1}	PLANNING	
11), ASHBURTON	SHBURTON 200 GA PLANS SIGHT LINES	DATE	29.11.2021	PROJECT NO. DRW NO.	REV.
		DRAWN	SHAUN	143 610-03	-
		CHECK	SHAUN		

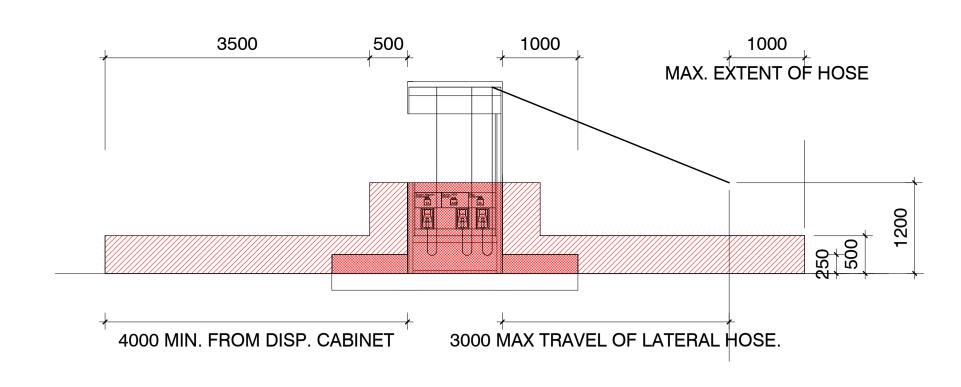

HAZNO AREA - PETROL DISPENSER1

ZONE CLASSIFICATION: AS/NZS 60079 (2009)

EXTERIOR OF PETROL DISPENSING UNITS IN ADEQUATELY VENTILATED LOCATIONS.

ZONE 1: A) WITHIN 0.05M ABOVE AND 0.1M BELOW THE DISPENSER NOZZLE SPOUT HOUSING AND EXTENDING 0.1M LATERALLY FROM THE DISPENSER HOUSING.

B) FOR DISPENSERS MOUNTED AT OR NEAR GROUND LEVEL, THE AREA WITHIN THE SPACE 0.25M ABOVE THE BASE OF THE DISPENSING EQUIPMENT AND EXTENDING 1.0M IN ALL DIRECTIONS HORIZONTALLY FROM THE DISPENSING UNIT.

ZONE 2:


2


SCALE 1 : 50

C) WITHIN THE SPACE 0.5M LATERALLY OF THE DISPENSING EQUIPMENT TO A HEIGHT OF 1.2M ABOVE THE BASE OF THE DISPENSER.
D) WITHIN THE SPACE 0.5M ABOVE THE DRIVEWAY OR GROUND LEVEL AND EXTENDING 4.0M IN ALL DIRECTIONS HORIZONTALLY FROM THE DISPENSING UNIT OR 1.0M FROM THE HOSE NOZZLE, WHICHEVER IS THE GREATER.

NOTE


THE DISTANCE OF 1.0M SPECIFIED IN D) IS TAKEN FROM THE END OF THE HOSE NOZZLE HEAD AT A HEIGHT OF 1.2M, AT ITS MAXIMUM LATERAL DISTANCE OF TRAVEL FROM THE DISPENSER UNIT IN ANY DIRECTION.

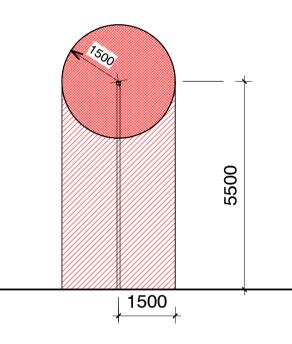

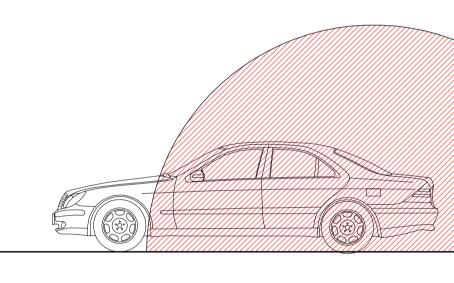





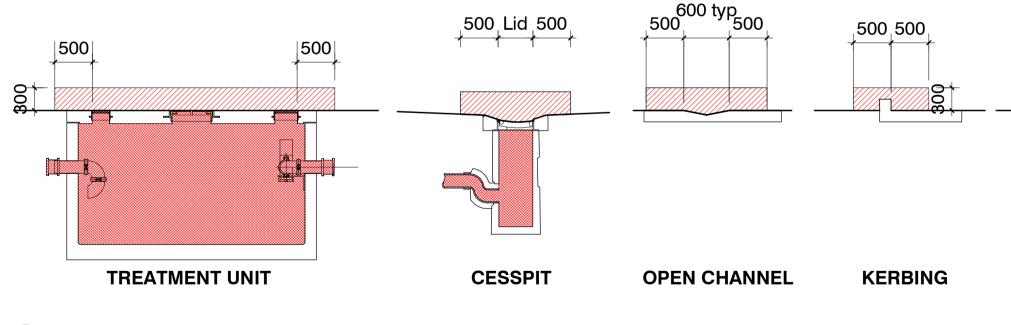

7 HAZNO AREA - CONTAMINATED SURFACE TREATMENT FIXTURES1 SCALE 1:50

ZONE CLASSIFICATION: AS/NZS 60079 (2009)

WASTE COLLECTION STORAGE VESSELS, DRAINS, SUMPS OR PITS ZONE 1:

A) THE AREA WITHIN COLLECTION DRAINS, SUMPS AND PITS LOCATED ON THE FORECOURT OF THE PETROL DISPENSING AREA.


ZONE 2: B) THE AREA WITHIN 0.3M VERTICAL AND 0.5M LATERAL FROM OPENINGS OF COLLECTION STORAGE VESSEL, DRAINS, SUMPS OR PITS.

ZONE 1:

C) INTERIOR OF COLLECTION STORAGE VESSEL

INTERPRETATION:

THE ABOVE ZONING ALSO APPLIES TO ALL CONTAMINATED STORMWATER CONTAINMENT/TREATMENT FEATURES. THIS INCLUDES AREAS WITHIN A WASTEWATER TREATMENT UNIT AS WELL AS ALL PIPING LEADING TO IT. THE DISTANCE OF 0.5M SPECIFIED IN B) IS TAKEN FROM THE EDGE OF OPENINGS (EG: RIM OF MANHOLE LID, CESSPIT LID) OR 0.5M BEYOND THE EDGES OF CONTAINED SURFACE FLOWS (EG: OPEN CHANNELS, ACO DRAINS, KERBING ETC)

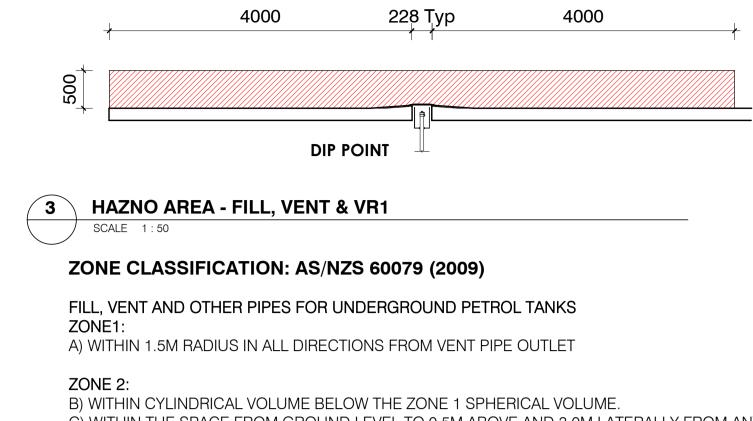


B) WITHIN CYLINDRICAL VOLUME BELOW THE ZONE 1 SPHERICAL VOLUME.
 C) WITHIN THE SPACE FROM GROUND LEVEL TO 0.5M ABOVE AND 3.0M LATERALLY FROM ANY FILL PIPE OR DIP PIPE OPENING

NOTE:


ALLOWANCES SHOULD BE MADE FOR POSSIBLE VARIATIONS IN TANKER POSITIONS. INTERPRETATION:


THE RADIUS OF 1.5M IN A) & B) IS TAKEN FROM THE OUTER EDGE OF THE VENT PIPE. THE DISTANCE OF 0.5M SPECIFIED

& C) IS TAKEN FROM THE EDGE OF OPENINGS (EG; RIM OF DIP OR FILL POINT)

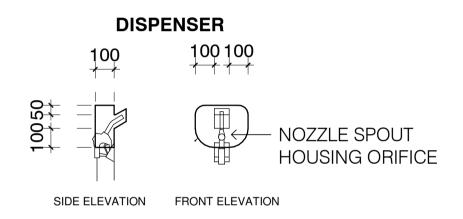



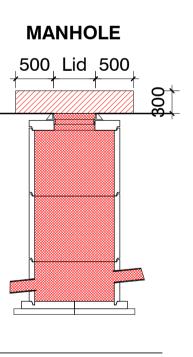

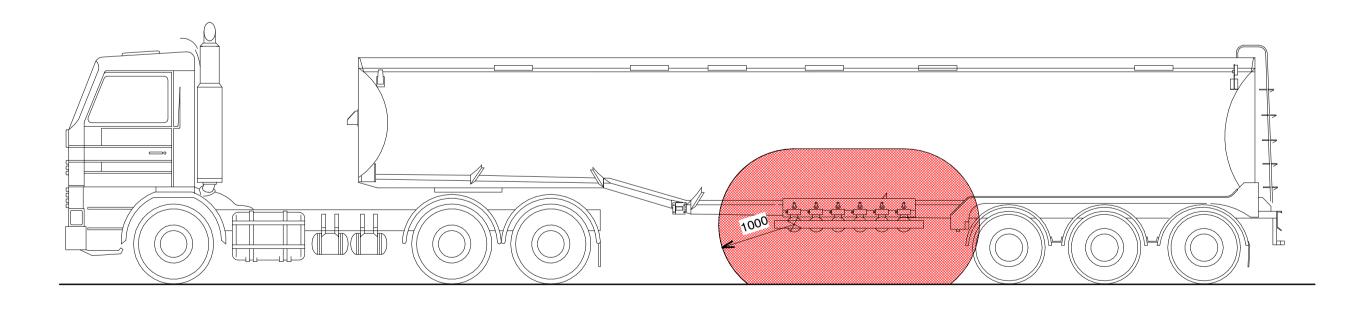

4 HAZNO AREA - SEMI TANKER WITH OR WITHOUT VR1 SCALE 1:50



HAZARDOUS ZONE LEGEND

CLASS 1 ZONE 2 CLASS 1 ZONE 1

URTON	N DRAWING		As indicated ^{@ A1} ^{x2} A3	PLANNING		
1), ASHBURTON	SHBURTON 600 HSNO DETAIL SHEET 01	DATE	15.09.2021	PROJECT NO. DRW NO. REV	1.	
		DRAWN	SHAUN	143 640-01 -		
		CHECK	SHAUN			